

**GENERAL NOTES**

- THE DRAWINGS AND PROJECT MANUAL TOGETHER CONSTITUTE THE CONTRACT DOCUMENTS FOR CONSTRUCTION. ALL GENERAL REQUIREMENTS ARE TO BE MET AND ALL MATERIALS, FINISHES AND SYSTEMS ARE TO BE INSTALLED AND PERFORM PER SPECIFICATIONS UNLESS OTHERWISE NOTED.
- GENERAL CONTRACTOR SHALL VISIT THE SITE, REVIEW THE BUILDING SHELL DRAWINGS AS SUBMITTED BY THE LANDLORD OR STARBUCKS AND BECOME THOROUGHLY FAMILIAR WITH THE SITE CONDITIONS PRIOR TO CONSTRUCTION.
- GENERAL CONTRACTOR SHALL CONSULT WITH STARBUCKS CONSTRUCTION MANAGER TO RESOLVE ANY CHANGES, OMISSIONS OR PLAN DISCREPANCIES PRIOR TO CONSTRUCTION.
- ALL WORK SHALL BE PERFORMED IN STRICT COMPLIANCE WITH LOCAL, COUNTY, STATE AND FEDERAL CODES AND ORDINANCES.
- GENERAL CONTRACTOR SHALL VERIFY THE LOCATION OF ALL UTILITIES.
- GENERAL CONTRACTOR TO VERIFY ALL DIMENSIONS, INCLUDING CLEARANCES REQUIRED BY OTHER TRADES AND NOTIFY STARBUCKS CONSTRUCTION MANAGER OF ANY DISCREPANCIES PRIOR TO PROCEEDING WITH THE WORK. ALL DIMENSIONS ARE TO THE FACE OF THE FINISHED SURFACE UNLESS NOTED OTHERWISE. ALL DIMENSIONS TO BE TAKEN FROM DESIGNATED DATUM POINT. DO NOT SCALE DRAWINGS.
- GENERAL CONTRACTOR SHALL PATCH AND REPAIR ALL EXISTING WALLS, FLOORS, CEILINGS OR OTHER SURFACES IDENTIFIED TO REMAIN THAT MAY BECOME DAMAGED DURING THE COURSE OF THE WORK.
- THE GENERAL CONTRACTOR IS RESPONSIBLE FOR OBTAINING PERMITS FOR FIRE PROTECTION, PLUMBING, MECHANICAL AND ELECTRICAL SYSTEMS PRIOR TO INSTALLATION OF SUCH SYSTEMS.
- GENERAL CONTRACTOR SHALL RETAIN ONE SET OF PERMIT PLANS ON-SITE TO DOCUMENT ALL CHANGES MADE DURING CONSTRUCTION. THE RECORD DRAWINGS SHALL BE ISSUED TO THE OWNER AT PROJECT CLOSE-OUT AS DESCRIBED IN THE GENERAL REQUIREMENTS OF THE PROJECT MANUAL.
- GENERAL CONTRACTOR IS RESPONSIBLE FOR COORDINATING DELIVERY OF MATERIALS FROM STARBUCKS CONTRACTED THIRD PARTY LOGISTICS DISTRIBUTION SERVICES AND VENDOR DIRECT SHIPMENTS. SEE THE PROJECT MANUAL FOR ADDITIONAL INFORMATION.
- RESPONSIBILITY FOR SUPPLY AND DELIVERY OF MATERIALS AND EQUIPMENT IS IDENTIFIED IN THE DRAWING SCHEDULE SHEETS UNDER THE COLUMN LABELED "RESPONSIBILITY".
- FOR THE PURPOSE OF THE DOCUMENTS, TO "INSTALL" SHALL MEAN TO PROVIDE ALL FASTENERS, MISCELLANEOUS HARDWARE, BLOCKING, ELECTRICAL CONNECTIONS, PLUMBING CONNECTIONS AND OTHER ITEMS REQUIRED FOR A COMPLETE AND OPERATIONAL INSTALLATION, UNLESS NOTED OTHERWISE.
- ALL ITEM SUBSTITUTIONS MUST BE APPROVED BY THE STARBUCKS CONSTRUCTION MANAGER.

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R - SHEET ISSUED FOR REFERENCE AND COORDINATION ONLY  
SEE TITLEBLOCK FOR REVISION ISSUE DATE(S)

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**SCOPE OF WORK**

INTERIOR TENANT IMPROVEMENT OF EXISTING SHELL BUILDING. SCOPE INCLUDES, BUT IS NOT LIMITED TO: PARTITIONS, EQUIPMENT, FINISHES, MECHANICAL, PLUMBING AND ELECTRICAL.

LANDLORD SHELL PERMIT NUMBER IS: BC22-000900

**SITE AND OCCUPANCY**

PROJECT DESCRIPTION: NEW TENANT IMPROVEMENT

BUILDING HEIGHT: 1 STORY

BUILDING AREA: 1406 SQ

BUILDING USE: COFFEE SHOP

ZONING: GC2 - GENERAL COMMERCIAL

TYPE OF USE: COFFEE SHOP

TYPE OF OCCUPANCY: B, BUSINESS

OCCUPANCY LOAD: BEVERAGE PREP : 487 SQ / 200 = 03  
WORKROOM : 600 SQ / 300 = 02  
TOTAL OCCUPANCY : = 05

TOTAL SQUARE FOOTAGE: 1406 SQ


COVERED PICK UP AREA: 622 SQ

EXIT CAPACITY: EXIT 1: 42" WIDE  
EXIT 2: 37" WIDE  
TOTAL EXIT WIDTH PROVIDED: 79 IN.  
0.2 X 5 OCCUPANTS = 1 IN. REQUIRED

TRAVEL DISTANCE: ALLOWED TRAVEL DISTANCE: 200' - 0"  
ACTUAL TRAVEL DISTANCE: 66' - 3"  
66' - 3" < 200' - 0" THEREFORE COMPLIES

NUMBER OF EXITS: MIN. NUMBER OF EXITS REQUIRED: 1  
NUMBER OF EXITS PROVIDED: 2

**VICINITY PLAN**

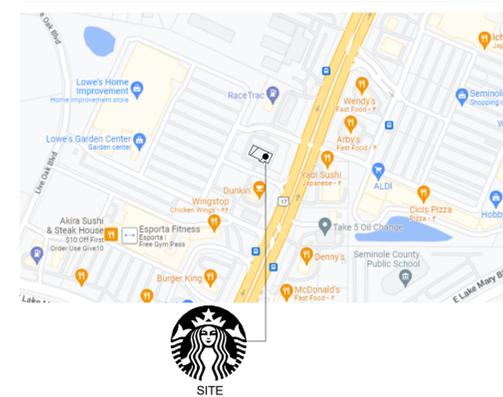

**APPLICABLE CODES**

7TH ED. 2020 FLORIDA BUILDING CODES

7TH EDITION 2020 FLORIDA BUILDING CODE: EXISTING BUILDINGS PLUMBING

NFPA 70 - 2017 NATIONAL ELECTRIC CODE

7TH EDITION 2020 FLORIDA BUILDING CODE: ENERGY CONSERVATION MECHANICAL FUEL-GAS

7TH EDITION 2020 FLORIDA BUILDING CODE: MECHANICAL

7TH EDITION 2020 FLORIDA FIRE PREVENTION CODE

**CODE CLASSIFICATION**

A. OCCUPANCY GROUP: B, BUSINESS

B. CONSTRUCTION CLASSIFICATION TYPE: II-B, NON-SPRINKLERED

C. AUTOMATIC FIRE SUPPRESSION SYSTEM INSTALLED: NO

D. ZONING: GC2 - GENERAL COMMERCIAL

E. JURISDICTION/ COUNTY: CITY OF SANDFORD

REVIEWED FOR CODE COMPLIANCE  
Wagne Thorne - PX3005 11-09-23  
A PERMIT ISSUED SHALL BE CONSTRUED TO BE A LICENSE TO PROCEED WITH THE WORK AND NOT AS AN AUTHORITY TO VIOLATE, CANCEL, ALTER OR SET ASIDE ANY OF THE PROVISIONS OF THE TECHNICAL CODES, NOR SHALL ISSUANCE OF A PERMIT PREVENT THE BUILDING OFFICIAL FROM THEREAFTER REQUIRING A CORRECTION OF ERRORS IN PLANS, CONSTRUCTION OR VIOLATIONS OF THIS CODE.

SITE COPY BC23-000692

BUILDING DEPARTMENT SANFORD



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STARBUCKS TEMPLATE VERSION: I2021-09-13

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FOR CONSTRUCTION

PROJECT NAME: US 17-92 & LAKE MARY BLVD  
PROJECT ADDRESS: 3764 ORLANDO DRIVE SANFORD, FL 23773

STORE #: 81065  
PROJECT #: 98504-001  
ISSUE DATE: 08-03-2023  
DESIGNER: PAULINA LOPEZ  
PRODUCTION DESIGNER: ANDY M CLOUD  
CHECKED BY: DONALD RETHMAN

Revision Schedule

Rev	Date	By	Description
1	09/27/23		Revision 1

SHEET TITLE: GENERAL INFORMATION

SCALE: NO SCALE

SHEET NUMBER: G-001

EGRESS CALCULATION	
EXIT WIDTH REQUIRED - 05 OCC X 0.2	= 1 IN.
EXIT WIDTH PROVIDED	= 79 IN.
EXITS	= 42 IN. PRIMARY ENTRY, 37 IN. PRIMARY ENTRY
EXITS REQUIRED	= 01
EXITS PROVIDED	= 02
MAXIMUM ALLOWABLE TRAVEL DISTANCE	= 200 FT. 0 IN.
MAXIMUM TRAVEL DISTANCE PROVIDED	= 66 FT. 3 IN.
MINIMUM EXIT SEPARATION	= 68 FT. 0 IN. (MAXIMUM DIAGONAL) / 2 = 34 FT 0 IN.
EXIT SEPARATION PROVIDED	= 51 FT. 6 IN.

PLUMBING FIXTURE CALCULATION					
CHAPTER 29-29023 (FOR REFERENCE ONLY)					
OCCUPANCY	05				
FIXTURES	WATERCLOSETS		URINALS	LAVATORIES	WATER FOUNTAIN
	ADD EQUATION PER AHJ		ADD EQUATION PER AHJ	ADD EQUATION PER AHJ	ADD EQUATION PER AHJ
	REQUIRED:	01 WC PER 25 M   01 WC PER 25 F	00 U PER M	01 LAV PER 40 M   01 LAV PER 40 F	NOT REQUIRED
PROVIDED:	01 WC PER 03 M   01 WC PER 03 F	00 U PER M	01 LAV PER 03 M   01 LAV PER 03 F	NOT REQUIRED	

OCCUPANCY	
BEVERAGE PREP (KITCHEN): 487 SQ. FT. / 200 SQ. FT. / OCC	03 OCC
WORKROOM (STORAGE): 600 SQ. FT. / 300 SQ. FT. / OCC	02 OCC
<b>TOTAL INTERIOR OCCUPANCY:</b>	<b>05 OCC</b>
<b>TOTAL EXTERIOR OCCUPANCY:</b>	<b>06 OCC</b>
<b>TOTAL OCC LOAD:</b>	<b>11 OCC</b>

### ROOM SCHEDULE

NAME	AREA (SF)
BEVERAGE PREP	487
EGRESS - UNOCCUPIABLE	319
WORKROOM	600
GRAND TOTAL	1406

### OCCUPANCY NOTES

OCCUPANCY CLASSIFICATION: B - BUSINESS  
 TOTAL OCCUPANTS: 05

### KEYED NOTES

- THRESHOLDS TO BE BARRIER FREE COMPLIANT PER ALL APPLICABLE CODES.
- BARRIER-FREE PATH OF TRAVEL.
- 60" (1525 MM) DIAMETER MINIMUM TURN RADIUS FOR WHEELCHAIR ACCESS.
- 32" (815 MM) MINIMUM CLEAR AT RESTROOM DOOR.
- SEE ENLARGED RESTROOM PLAN AND ELEVATIONS SHEET(S) FOR ADDITIONAL INFORMATION ON ACCESSIBLE RESTROOM CLEARANCES.
- PROVIDE BARRIER-FREE SIGNAGE AT ADA RESTROOMS PER ALL APPLICABLE CODES.
- PROVIDE TACTILE "EXIT" SIGNAGE.
- PROVIDE INTERNATIONAL SYMBOL OF ACCESSIBILITY SIGN.

### MEANS OF EGRESS NOTES

- EVERY ROOM OR SPACE THAT IS ASSEMBLY OCCUPANCY SHALL HAVE THE OCCUPANT LOAD OF THE ROOM OR SPACE POSTED IN A CONSPICUOUS PLACE, NEAR THE MAIN EXIT ACCESS DOORWAY. POSTED SIGNS SHALL BE OF AN APPROVED LEGIBLE PERMANENT DESIGN AND SHALL BE MAINTAINED BY THE OWNER AUTHORIZED AGENT. (1004.3)
- EGRESS SHALL NOT PASS THROUGH KITCHENS, STORAGE ROOMS, CLOSETS OR SIMILAR SPACES. (1014.2)
- PANIC AND FIRE EXIT HARDWARE, WHERE INSTALLED ON DOORS IN THIS BUILDING SHALL SATISFY THE FOLLOWING (1008.1.10):
  - THE ACTUATION PORTION OF THE RELEASING DEVICE SHALL EXTEND AT LEAST ONE-HALF OF THE DOOR LEAF WIDTH.
  - THE MAXIMUM UNLATCHING FORCE DOES NOT EXCEED 15 POUNDS (6.8 KG).
  - PIVOTED OR BALANCED DOORS SHALL BE OF THE PUSH-PAD TYPE WHERE PANIC HARDWARE IS REQUIRED AND THE PAD SHALL NOT EXTEND ACROSS MORE THAN ONE-HALF OF THE DOOR WIDTH, MEASURED FROM THE LATCH SIDE.
  - PANIC HARDWARE LISTED IN ACCORDANCE WITH UL 305.
  - FIRE EXIT HARDWARE LISTED IN ACCORDANCE WITH UL 10C AND UL 305.
- STRUCTURAL ELEMENTS, FIXTURES OR FURNISHINGS SHALL NOT PROJECT HORIZONTALLY FROM EITHER SIDE MORE THAN 4 INCHES (100 MM) OVER ANY WALKING SURFACE BETWEEN 27 INCHES (685 MM) AND 80 INCHES (2030 MM) ABOVE THE WALKING SURFACE. EXCEPTION: HANDRAILS SERVING STAIRS AND RAMPS ARE PERMITTED TO PROTRUDE 4 1/2 INCHES (115 MM) FROM THE WALL. (1003.3.3)ES (1120 MM), (1008.1.5, 1008.1.6)
- THE PATH OF EGRESS TRAVEL EXITS AND WITHIN EXITS IN THIS BUILDING SHALL BE IDENTIFIED BY EXIT SIGNS CONFORMING TO THE REQUIREMENTS OF SECTION 1011 AND AS NOTED BELOW:
  - EXIT SIGNS SHALL BE READILY VISIBLE FROM ANY DIRECTION OF EGRESS TRAVEL.
  - EXIT SIGNS SHALL BE LOCATED AS NECESSARY TO CLEARLY INDICATE THE DIRECTION OF EGRESS TRAVEL.
  - NO POINT IN A CORRIDOR SHALL BE MORE THAN 100 FT (30.5 M OR THE LISTED VIEWING DISTANCE FOR THE SIGN, WHICHEVER IS LESS, FROM THE NEAREST VISIBLE EXIT SIGN.
- WHERE KEY OPERATED LOCKING DEVICES ARE USED, POST A SIGN ON OR ADJACENT TO THE REQUIRED MAIN EXIT DOOR WITH 1 INCH (25 MM) LETTERING STATING THAT "THIS DOOR TO REMAIN UNLOCKED WHEN BUILDING IS OCCUPIED". (1008.1.9.3)
- EGRESS DOORS OR GATES SHALL BE OPENABLE FROM THE EGRESS SIDE WITHOUT THE USE OF A KEY, SPECIAL KNOWLEDGE OR EFFORT. DOOR HANDLES, PULLS, LATCHES, LOCKS AND OTHER OPERATING DEVICES SHALL BE INSTALLED 34 INCHES (860 MM) TO 48 INCHES (1220 MM) ABOVE FINISHED FLOOR. MANUALLY OPERATED FLUSH BOLTS OR SURFACE BOLTS ARE NOT PERMITTED. THE UNLATCHING OF ANY DOOR OR LEAF SHALL NOT REQUIRE MORE THAN ONE OPERATION. (1008.1.9)
- LANDINGS SHALL BE PROVIDED ON EACH SIDE OF DOORS AND SUCH LANDING SHALL BE AT THE SAME ELEVATION ON EACH SIDE OF THE DOOR. LANDINGS SHALL HAVE A WIDTH NOT LESS THAN THE WIDTH OF THE DOOR AND LENGTH MEASURED IN THE DIRECTION OF TRAVEL OF NOT LESS THAN 44 INCHES (1120 MM). (1008.1.5, 1008.1.6)

REVIEWED FOR CODE COMPLIANCE  
 Wayne Thorne - PX3005 11-09-23  
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 SITE COPY BC23-000692  
 BUILDING DEPARTMENT SANFORD



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STARBUCKS TEMPLATE VERSION: I2021-09-13

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FOR CONSTRUCTION

PROJECT NAME:  
**US 17-92 & LAKE MARY BLVD**


PROJECT ADDRESS:  
**3764 ORLANDO DRIVE  
 SANFORD, FL 23773**

STORE #: 81065  
 PROJECT #: 98504-001  
 ISSUE DATE: 08-03-2023  
 DESIGNER: PAULINA LOPEZ  
 PRODUCTION DESIGNER: ANDY MCLLOUD  
 CHECKED BY: DONALD RETHMAN

Revision Schedule			
Rev	Date	By	Description

SHEET TITLE:  
**LIFE SAFETY ACCESSIBILITY PLAN**  
 SCALE: 1/4" = 1'-0"

SHEET NUMBER:  
**G-002**

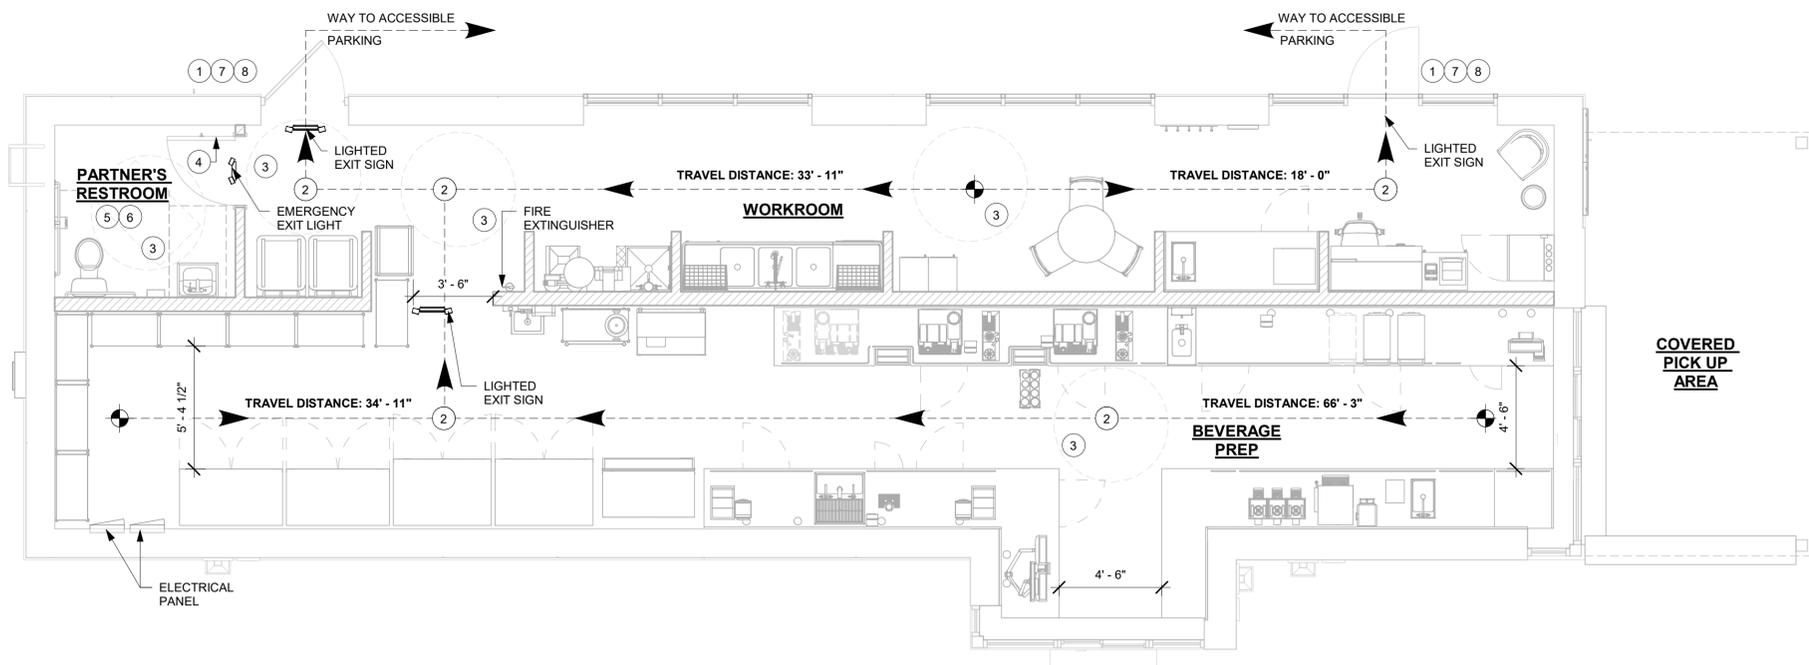

### 1 LIFE SAFETY ACCESSIBILITY PLAN

Scale: 1/4" = 1'-0"




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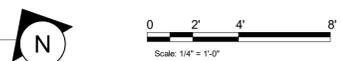
**AREA COLOR LEGEND**

<span style="display:inline-block; width:10px; height:10px; background-color:yellow; border:1px solid black;"></span> - BEVERAGE PREP.
<span style="display:inline-block; width:10px; height:10px; background-color:cyan; border:1px solid black;"></span> - WORKROOM - STORAGE
<span style="display:inline-block; width:10px; height:10px; background-color:white; border:1px solid black;"></span> - RESTROOM / UNOCCUPIABLE

AREA - OCCUPANT LOAD CALCS			
NAME	Area (SF)	LOAD FACTOR	OCCUPANT LOAD
BEVERAGE PREP	487	200	3
EGRESS - UNOCCUPIABLE	319	0	0
WORKROOM/STORAGE	600	300	2
GRAND TOTAL	1406		5

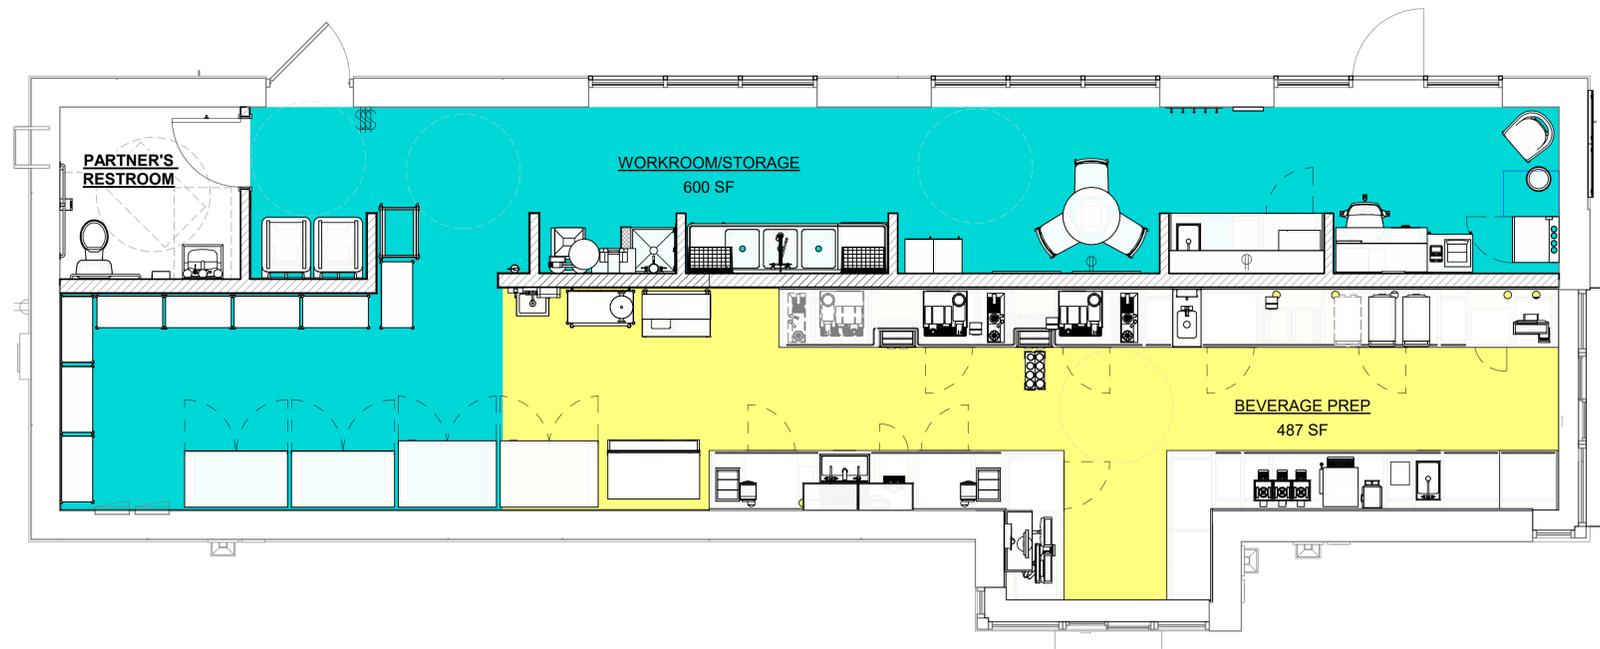

**1 OCCUPANCY LOAD PLAN**  
Scale: 1/4" = 1'-0"



**REVIEWED FOR CODE COMPLIANCE**  
Wade Thorne - PX3005 11-09-23  
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STARBUCKS TEMPLATE VERSION: 12021-09-13

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Professional Engineer  
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**FOR CONSTRUCTION**

PROJECT NAME:  
**US 17-92 & LAKE MARY BLVD**

PROJECT ADDRESS:  
**3764 ORLANDO DRIVE  
SANFORD, FL 23773**

STORE #: 81065  
PROJECT #: 98504-001  
ISSUE DATE: 08-03-2023  
DESIGNER: PAULINA LOPEZ  
PRODUCTION DESIGNER: ANDY MCLLOUD  
CHECKED BY: DONALD RETHMAN

Revision Schedule			
Rev	Date	By	Description

SHEET TITLE:  
**OCCUPANCY LOAD PLAN**  
SCALE: 1/4" = 1'-0"

SHEET NUMBER:  
**G-002.1**

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 Wayne Thorne - PX3005 11-09-23  
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STARBUCKS TEMPLATE VERSION: I2021-09-13

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11/06/2023

**FOR CONSTRUCTION**

PROJECT NAME:  
**US 17-92 & LAKE MARY BLVD**







PROJECT ADDRESS:  
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 SANFORD, FL 32773**

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 PRODUCTION DESIGNER: ANDY MCLLOUD  
 CHECKED BY: DONALD RETHMAN

Revision Schedule			
Rev	Date	By	Description

SHEET TITLE:  
**ACCESSIBILITY GUIDELINES**  
 SCALE: NO SCALE

SHEET NUMBER:  
**G-003**

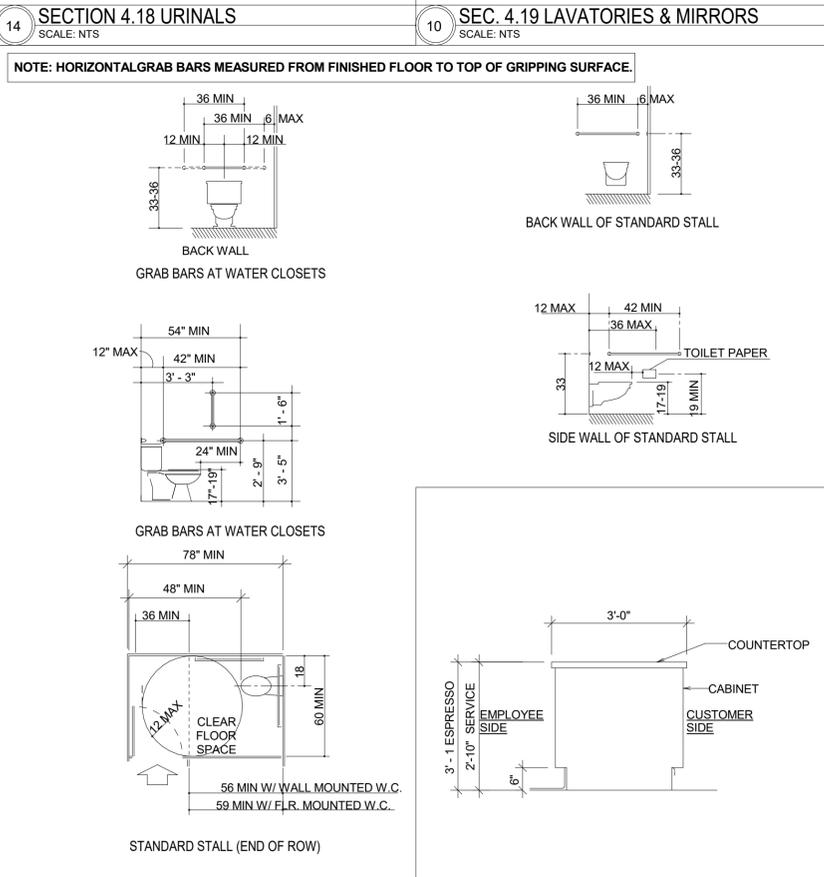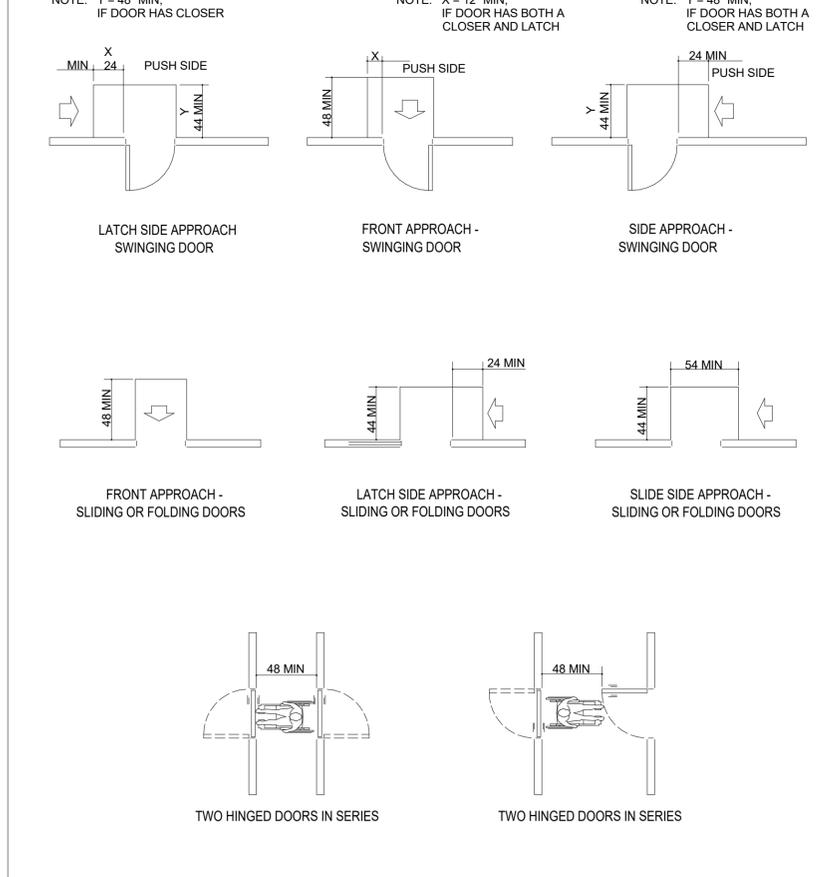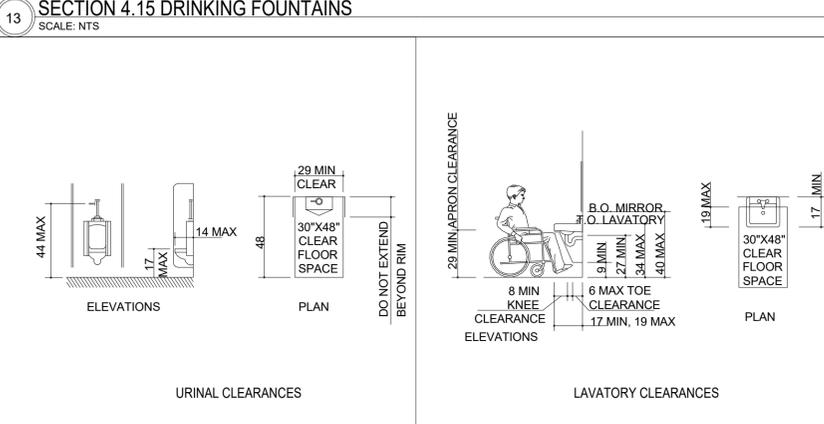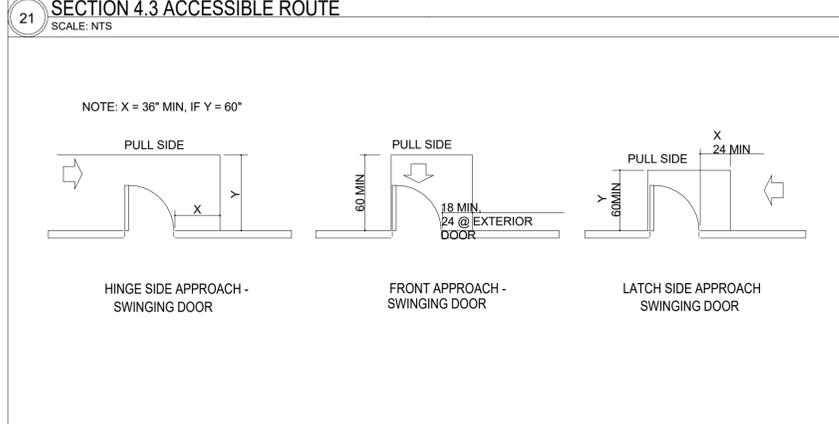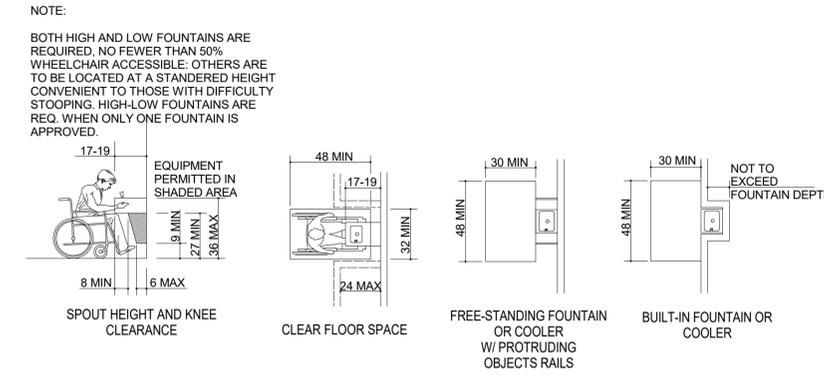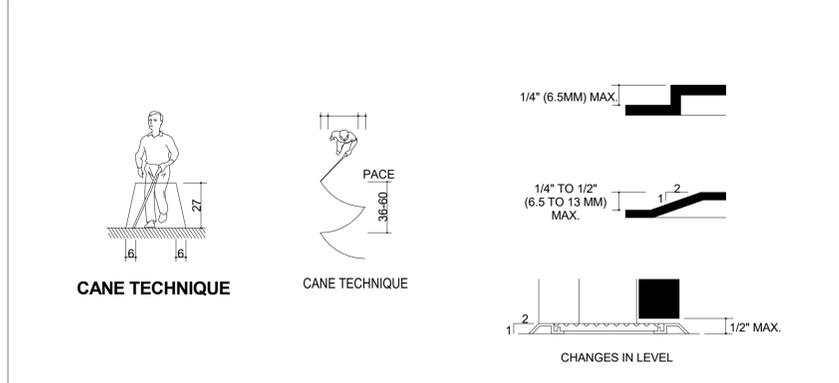

**SECTION 4.13 DOORS**  
 SCALE: NTS

**SECTION 4.17 TOILET STALLS**  
 SCALE: NTS

**TYP SECTION @ COUNTER**  
 SCALE: NTS

**SECTION 4.2 SPACE ALLOWANCES**  
 SCALE: NTS

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**SHEET NOTES**

- A1. 60" DIAMETER CLEAR FOR WHEELCHAIR ACCESS.
- A2. ALL THRESHOLDS TO BE ADA COMPLIANT PER ALL APPLICABLE CODES.
- A3. BARRIER FREE PATH OF TRAVEL.
- A4. ADA MANEUVERING CLEARANCE AT DOORS; FRONT APPROACH, PUSH SIDE, DOOR PROVIDED WITH CLOSER: 48" MIN. BY 48" MIN.
- A5. ADA MANEUVERING CLEARANCE AT DOORS; FRONT APPROACH, PULL SIDE, DOOR PROVIDED WITH CLOSER: 54" MIN. BY 60" MIN.
- A6. HAND SINKS AND LAVATORIES TO BE 2'-10" AFF AND 30" X 48" CLEAR FOR WHEELCHAIR ACCESSIBILITY.

**GENERAL NOTES**

- 1. GENERAL CONTRACTOR SHALL VISIT THE SITE, REVIEW THE BUILDING SHELL DRAWINGS AS SUBMITTED BY THE LANDLORD OR STARBUCKS SITE SURVEYOR AND BECOME THOROUGHLY FAMILIAR WITH THE SITE CONDITIONS PRIOR TO BIDDING OR CONSTRUCTION.
- 2. GENERAL CONTRACTOR SHALL CONSULT WITH STARBUCKS CONSTRUCTION MANAGER TO RESOLVE ANY CHANGES, OMISSIONS OR PLAN DISCREPANCIES PRIOR TO BIDDING OR CONSTRUCTION.
- 3. ALL WORK SHALL BE PERFORMED IN STRICT COMPLIANCE WITH LOCAL, COUNTY, STATE AND FEDERAL CODES AND ORDINANCES.
- 4. GENERAL CONTRACTOR SHALL VERIFY THE LOCATION OF ALL UTILITIES.
- 5. GENERAL CONTRACTOR TO VERIFY ALL DIMENSIONS, INCLUDING CLEARANCES REQUIRED BY OTHER TRADES AND NOTIFY STARBUCKS CONSTRUCTION MANAGER OF ANY DISCREPANCIES PRIOR TO PROCEEDING WITH THE WORK. ALL DIMENSIONS ARE TO THE FACE OF THE FINISHED SURFACE UNLESS OTHERWISE NOTED. ALL DIMENSIONS TO BE TAKEN FROM DESIGNATED DATUM POINT. DO NOT SCALE DRAWINGS.
- 6. GENERAL CONTRACTOR SHALL PATCH AND REPAIR ALL EXISTING WALLS, FLOORS, CEILINGS OR OTHER SURFACES IDENTIFIED TO REMAIN THAT MAY BECOME DAMAGED DURING THE COURSE OF THE WORK.
- 7. THE GENERAL CONTRACTOR IS RESPONSIBLE FOR OBTAINING PERMITS FOR FIRE PROTECTION, PLUMBING, MECHANICAL AND ELECTRICAL SYSTEMS PRIOR TO INSTALLATION OF SUCH SYSTEMS.
- 8. GENERAL CONTRACTOR SHALL RETAIN ONE SET OF THE PLANS TO NOTE AND DOCUMENT ALL CHANGES DURING CONSTRUCTION. THIS SET SHALL BE A PART OF THE GENERAL CONTRACTOR'S "STORE CLOSE-OUT PACKAGE" AS DESCRIBED IN THE CONSTRUCTION MANAGEMENT AGREEMENT.
- 9. GENERAL CONTRACTOR IS RESPONSIBLE FOR COORDINATING DELIVERY OF MATERIALS FROM STARBUCKS CONTRACTED THIRD PARTY LOGISTICS DISTRIBUTION SERVICES AND VENDOR DIRECT SHIPMENTS. REFER TO CONSTRUCTION MANAGEMENT AGREEMENT FOR METHODS AND LEAD TIMES.
- 10. RESPONSIBILITY FOR SUPPLY AND DELIVERY OF MATERIALS AND EQUIPMENT IS IDENTIFIED IN THE DRAWING SCHEDULE SHEETS UNDER THE COLUMN LABELED "RESPONSIBILITY".
- 11. FOR THE PURPOSE OF THE DOCUMENTS, TO "INSTALL", SHALL MEAN TO PROVIDE ALL FASTENERS, MISCELLANEOUS HARDWARE, BLOCKING, ELECTRICAL CONNECTIONS, PLUMBING CONNECTIONS, AND OTHER ITEMS REQUIRED FOR A COMPLETE AND OPERATION INSTALLATION, UNLESS OTHERWISE NOTED.
- 12. ALL ITEM SUBSTITUTIONS MUST BE APPROVED BY THE STARBUCKS DESIGN MANAGER.
- 13. REFER TO ITEM CUTSHEETS FOR ADDITIONAL INFORMATION.

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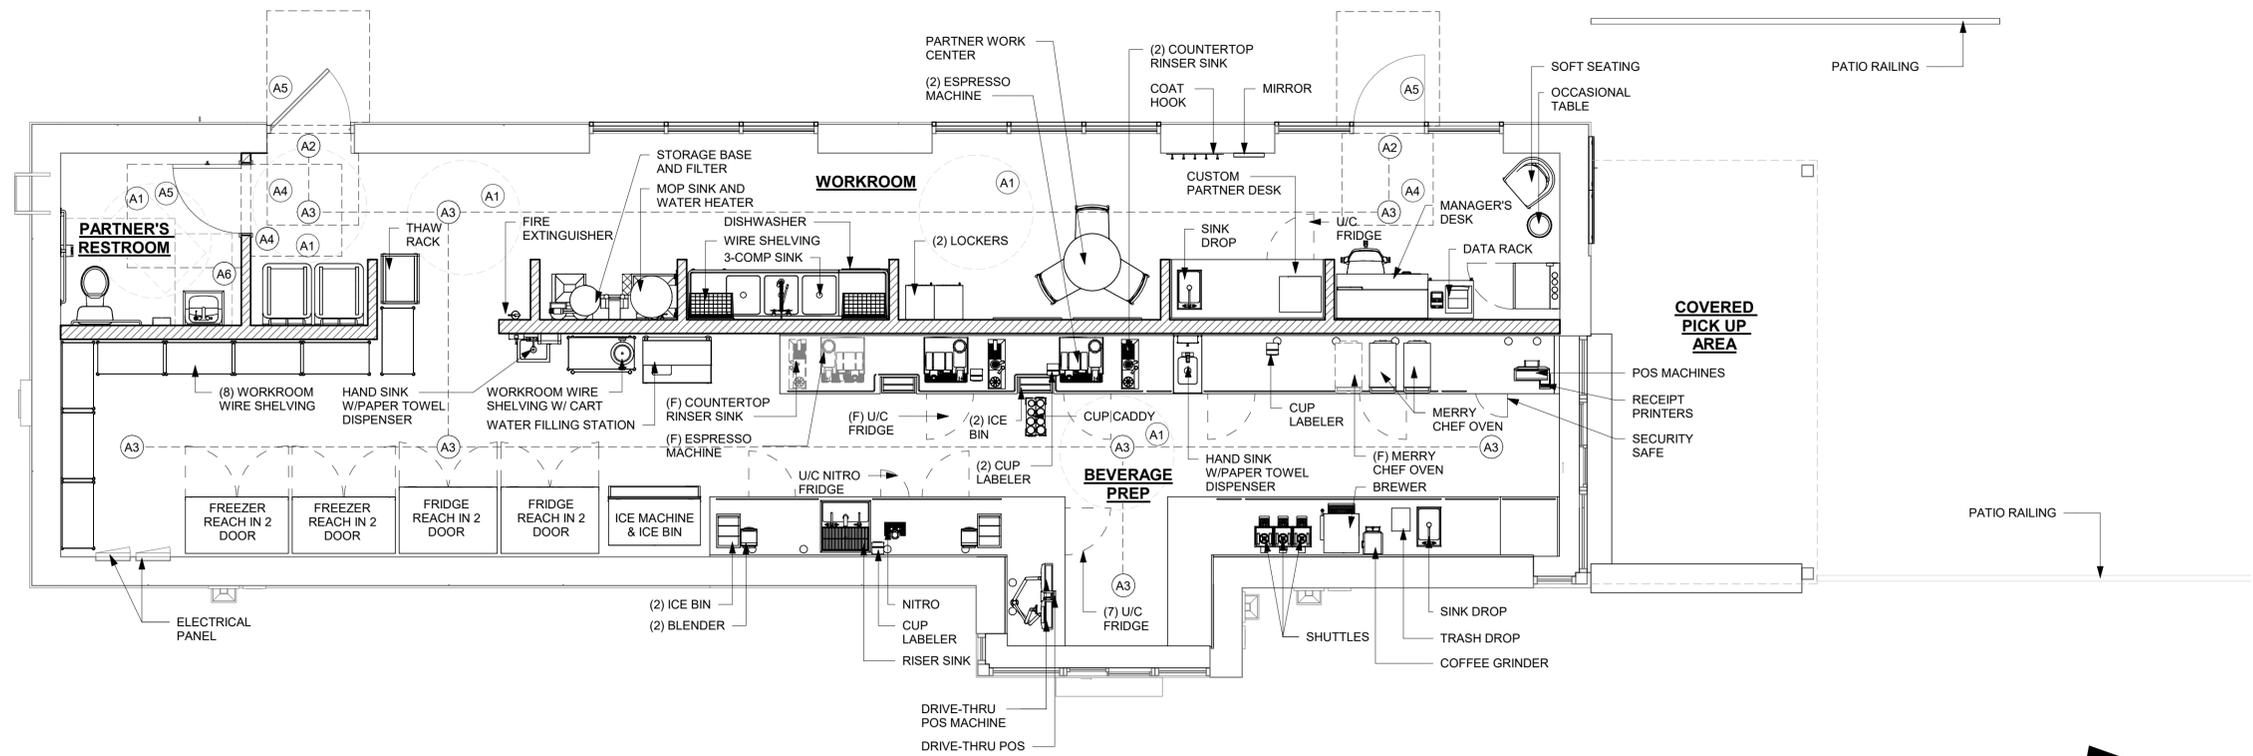
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Revision Schedule			
Rev	Date	By	Description

SHEET TITLE:  
**FOOD SERVICE PLAN**

SCALE: 1/4" = 1'-0"

SHEET NUMBER:  
**G-004**



**1 FOOD SERVICE PLAN**  
 Scale: 1/4" = 1'-0"

**GC REQUIREMENTS FOR STARBUCKS GREENER STORES**

PRE-CHECKED ITEMS ARE LEED PREREQUISITES FOR NEW AND RELOCATED COMPANY OWNED STORES. PLEASE REFER TO THE LEED SCORECARD TO VERIFY TARGETED CREDITS.

**BEFORE CONSTRUCTION**

- TALK TO WASTE HAULER TO MAKE SURE THEY CAN RECYCLE AT LEAST 50% OF YOUR CONSTRUCTION WASTE.
  - YOU WILL NEED TO SUBMIT DUMP TICKETS AND DIVERSION RATES SHOWING AT LEAST 50% WAS RECYCLED.
- CONFIRM CO-MINGLED RECYCLER CAN PROVIDE A DIVERSION RATE BASED ON WEIGHT OF INDIVIDUAL RECYCLABLES (WOOD, METAL, ADC, CONCRETE ETC.). DIVERSION RATE CAN BE BY CONTAINER OR A FACILITY WIDE AVERAGE (MONTHLY OR ANNUAL). VISUAL CLASSIFICATION IS NOT ACCEPTABLE.
- SOURCE-SEPARATED RECYCLABLES DO NOT NEED A PUBLISHED DIVERSION RATE AND CAN BE ASSUMED TO BE 100%.
- REVIEW IAQ MANAGEMENT PLAN WITH PROJECT TEAM (FOUND IN THE GC ADMINISTRATION HANDBOOK).
- REVIEW PRE-APPROVED PRODUCT LIST WITH PROJECT TEAM (FOUND IN THE GC ADMINISTRATION HANDBOOK).
- ENSURE THAT THE ENTIRE CONSTRUCTION TEAM, INCLUDING SUB-CONTRACTORS, ARE AWARE OF THEIR LEED ROLES AND RESPONSIBILITIES.

**DURING CONSTRUCTION**

- INSTALL LOW-FLOW TOILETS AND AERATORS (1.28 GPF OR BETTER, 0.5 GPM AERATORS, 1.2 GPM PRE-RINSE SPRAY VALVE).
- KEEP TRACK OF DUMP TICKETS.
- KEEP TRACK OF ADHESIVES, SEALANTS, PAINTS AND OTHER EQc4 PRODUCTS USED.
- POST IAQ MANAGEMENT PLAN ON THE JOB SITE.
- POST PRE-APPROVED PRODUCT LIST.
- COMPLETE 2 SITE INSPECTION CHECKLISTS TO VERIFY BEST PRACTICES USED FOR MAINTAINING GOOD INDOOR AIR QUALITY DURING CONSTRUCTION. PHOTOS CAN HELP DOCUMENT THESE:
  - CLEAN WORK SITE AT BEGINNING OR END OF EACH DAY TO CONTROL DUST.
  - MAKE SURE DUCT WORK IS DELIVERED WITH ENDS COVERED.
  - PROTECT DUCTWORK BY SEALING OPENINGS IMMEDIATELY AFTER INSTALLATION.
  - IF THE USE OF THE PERMANENT HVAC EQUIPMENT IS UNAVOIDABLE DURING CONSTRUCTION, INSTALL A TEMPORARY MERV 8 FILTER ON ALL SUPPLY AND RETURN GRILLES AND OPENINGS. TO BE REPLACED WITH NEW MERV 8 FILTERS BEFORE TAB WORK AND FINAL SYSTEM COMMISSIONING.
  - USE WALK-OFF MATS AT ENTRIES FOR DUST CONTROL.
  - USE FAN OR OTHER METHOD OF CLEARING DUST FROM AIR DURING CONSTRUCTION.
  - KEEP DELIVERED BUT NOT-YET-INSTALLED EQUIPMENT/MATERIALS COVERED IN PLASTIC AND RAISED OFF OF THE GROUND TO PREVENT MOISTURE DAMAGE.
  - DO NOT INSTALL CONTAMINATED MATERIALS.
  - POST NO SMOKING SIGN.
  - USE LOW VOC PRODUCTS, AS PER PRE-APPROVED LIST, OR VERIFIED VIA MSD SHEETS.
  - USE ELECTRIC TOOLS WITH VACUUM-ASSIST, NOT GAS-POWERED TOOLS.
  - CUT AND FABRICATE MATERIALS OUTSIDE WHENEVER POSSIBLE.

**AT END OF CONSTRUCTION**

- SUBMIT:**
  - TAB REPORT, WITH ACTUAL OUTSIDE AIR VOLUMES INDICATED AND BALANCED AS PER DESIGN CFM ON DRAWINGS.
  - TWO IAQ SITE INSPECTION CHECKLISTS.
  - SIGNED EQc4 AFFIDAVIT -OR- FILL OUT EQc4 REPORT IF USED NON-PREAPPROVED PRODUCTS FOR LOW-EMITTING MATERIALS: PAINTS, COATINGS, ADHESIVES, SEALANTS, CEILINGS, WALLS AND COMPOSITE WOOD PRODUCTS.
  - CONSTRUCTION WASTE MANAGEMENT REPORT.
  - PROOF OF CONSTRUCTION WASTE DIVERSION RATE VIA DUMP TICKETS, SUMMARY REPORT OR RECYCLING FACILITY DIVERSION RATE.
- VERIFY:**
  - ENSURE LOW-FLOW FIXTURES ARE INSTALLED:
    - TOILETS: 1.28 GPF OR BETTER
    - HAND SINKS: 0.5 GPM AERATORS
    - PRE-RINSE SPRAY VALVE: 1.2 GPM
  - BICYCLE RACK IS INSTALLED
  - BICYCLE REPAIR KIT IS ON-SITE
  - ENSURE A COMBINATION OF OVERHANGS AND/OR BLINDS ARE INSTALLED FOR ALL WINDOWS TO MITIGATE SOLAR HEAT GAIN AND GLARE.
  - GREEN EDUCATION DISKS ARE INSTALLED AS INDICATED ON DRAWINGS.

**CONTRACTOR RESPONSIBILITIES FOR BUILDING COMMISSIONING**

CONTRACTOR SHALL PROVIDE SUPPORT AND WORKS AS SPECIFIED, NEEDED AND REQUIRED TO CONDUCT AND FACILITATE STARBUCKS STAFF BUILDING COMMISSIONING EFFORTS. THIS WORK WILL BE COMPRISED OF THREE DISTINCT EFFORTS:

1. SUPPORT STARBUCKS COMMISSIONING AGENT (CXA) DURING INSTALLATION VERIFICATION AND CORRECT DISCLOSED DEFICIENCIES;
2. PERFORM TESTING, ADJUSTING, BALANCING AND SYSTEM STARTUP AND SUPPORT FUNCTIONAL PERFORMANCE TESTING BY STARBUCKS CXA. 3) CORRECT DEFICIENCIES DISCLOSED BY FUNCTIONAL PERFORMANCE TESTING AND SUBMIT REPORTS. CONTRACTOR SHALL PERFORM AND PROVIDE THE FOLLOWING:
  - A. SYSTEMS SUBJECT TO COMMISSIONING MAY INCLUDE, BUT ARE NOT LIMITED TO, DOMESTIC HOT WATER GENERATION, HVAC SYSTEMS, ROOFTOP UNITS, EXHAUST FANS, HVAC CONTROLS, LIGHTING CONTROLS, AIR CURTAINS, BUILT-INN REFRIGERATION EQUIPMENT AND RENEWABLE ENERGY SYSTEMS.
  - B. CONTRACTOR SHALL INCLUDE COMMISSIONING ACTIVITIES IN PROJECT SCHEDULE AND SHOW INTERVALS FOR PERFORMANCE OF WORK FOR WHICH CONTRACTOR IS RESPONSIBLE AND INTERVALS FOR WORK PERFORMED BY STARBUCKS CXA. CONTRACTOR SHALL SHOW RESOURCES FOR PERFORMING ALL WORK RELATED TO COMMISSIONING ACTIVITIES ON A LINE ITEM IN THE SCHEDULE OF VALUES.
  - C. CONTRACTOR SHALL INSTALL EQUIPMENT IN ACCORDANCE WITH THE MANUFACTURER'S REQUIREMENTS AND ALL CONTRACT DOCUMENTS. ENSURE THAT ALL EQUIPMENT IS INSTALLED TOTALLY COMPLETE AND ACCESSIBLE TO STARBUCKS CXA FOR INSTALLATION VERIFICATION AND FUNCTIONAL PERFORMANCE TESTING PRIOR TO THE SCHEDULED START OF INSTALLATION VERIFICATIONS.
  - D. INSTALLATION VERIFICATION SHALL BE PERFORMED BY STARBUCKS' CXA. CONTRACTOR SHALL SUPPORT STARBUCKS CXA INSTALLATION VERIFICATION EFFORTS AS NECESSARY. PROVIDE ALL ACCESS AND EQUIPMENT NECESSARY FOR STARBUCKS STAFF TO VERIFY THAT THE EQUIPMENT IS INSTALLED CORRECTLY.
  - E. CONTRACTOR SHALL BE READILY AVAILABLE DURING INSTALLATION VERIFICATION TO CORRECT ANY DEFICIENCIES OR DEFECTS DISCLOSED BY THE INSTALLATION VERIFICATION PROCESS. CORRECTIONS SHALL BE MADE IN A TIMELY MANNER WITHOUT DISRUPTION OF THE CONSTRUCTION SCHEDULE.
  - F. ALL HVAC, EXHAUST FAN AND AIR CURTAIN EQUIPMENT SHALL BE TESTED, ADJUSTED AND BALANCED BY THE CONTRACTORS TESTING, ADJUSTING AND BALANCE AGENT (SEE TESTING, ADJUSTING AND BALANCING) AFTER THE SYSTEM IS VERIFIED TO BE COMPLETE AND CORRECT BY STARBUCKS CXA, IN ACCORDANCE WITH THE REQUIREMENTS OF THESE DOCUMENTS. ALL HVAC CONTROL SYSTEMS SHALL BE TESTED TO ENSURE THAT CONTROL DEVICES, COMPONENTS, EQUIPMENT AND SYSTEMS ARE CALIBRATED, ADJUSTED AND OPERATE IN ACCORDANCE WITH THESE PLANS AND SPECIFICATIONS. SEQUENCES OF OPERATION CALIBRATED, ADJUSTED AND OPERATE IN ACCORDANCE WITH THESE PLANS AND SPECIFICATIONS. SEQUENCES OF OPERATION SHALL BE TESTED TO ENSURE THAT THEY OPERATE IN ACCORDANCE WITH THE CONTRACT REQUIREMENTS. DELIVERABLES: PRELIMINARY, WRITTEN TESTING AND AIR BALANCE REPORT CONFORMING TO THE REQUIREMENTS SPECIFIED HEREIN. DOCUMENTING THE INFORMATION SPECIFIED, ETC. TO THE STARBUCKS CXA IMMEDIATELY UPON COMPLETION OF THE WORK.
  - G. CONTRACTOR SHALL INFORM STARBUCKS CXA WHEN EQUIPMENT IS READY FOR FUNCTIONAL PERFORMANCE TESTING. ALL EQUIPMENT SHALL BE READY FOR FUNCTIONAL PERFORMANCE TESTING PRIOR TO STARTING TESTING. CONTRACTOR SHALL OPERATE EQUIPMENT FOR STARBUCKS CXA AND VERIFY BY DEMONSTRATION THE CORRECT OPERATION OF EQUIPMENT, RESPONSE OF SENSORS AND PROPER EXECUTION OF HVAC CONTROL AND LIGHTING SEQUENCES, INCLUDING BUT NOT LIMITED TO AIR MOVEMENT, TEMPERATURE, SOUND AND CONTROL RESPONSE. PROVIDE ANY SECURITY ACCESS, HARDWARE, SOFTWARE OR OTHER SUPPORT AS NEEDED FOR THE STARBUCKS CXA TO EFFICIENTLY WITNESS AND DOCUMENT ALL EQUIPMENT TESTING. STARBUCKS CXA WILL RECORD TED EQUIPMENT OPERATION AND RESPONSE TO TESTING SEQUENCES AND PREPARE A LIST OF ANY DEFICIENCIES DISCLOSED BY THE FUNCTIONAL PERFORMANCE TESTS FOR CORRECTION BY THE CONTRACTOR. EQUIPMENT INCLUDES BUT IS NOT LIMITED TO, AIR HANDLING UNITS, ROOFTOP AND SPLIT TYPE, CONDENSING UNITS, EXHAUST FANS, LIGHTING CONTROLS, ETC. DELIVERABLES: PROVIDE COMPLETED COPIES OF ALL START UP REPORTS, FILLED OUT ON THE MANUFACTURERS FORMS, TO THE STARBUCKS CXA.
  - H. CONTRACTOR IS RESPONSIBLE FOR CORRECTING ANY ISSUES OR DEFICIENCIES DISCLOSED DURING THE FUNCTIONAL PERFORMANCE TESTING PROCESS. CORRECTIONS SHOULD BE MADE IN A TIMELY MANNER WITHOUT DISRUPTION TO THE SYSTEM AND CONSTRUCTION SCHEDULE.
  - I. CONTRACTOR SHALL BE READILY BE AVAILABLE FOR ANY RE-TESTING OF EQUIPMENT DEEMED NECESSARY BY STARBUCKS CXA DURING INSTALLATION VERIFICATION AND FUNCTIONAL PERFORMANCE TESTING. CONTRACTOR IS RESPONSIBLE FOR CORRECTING ANY ISSUES OR DEFICIENCIES FOUND IN THE SYSTEM DURING ANY AND ALL RETESTING. CORRECTIONS SHOULD E MADE IN A TIMELY MANNER WITHOUT DISRUPTION TO THE SYSTEM AND CONSTRUCTION SCHEDULE. DELIVERABLES: FINAL BALANCE REPORT, DEFICIENCIES LIST NOTING CORRECTIVE ACTIONS PERFORMED BY CONTRACTOR IN RESPONSE TO INSTALLATION VERIFICATION AND FUNCTIONAL PERFORMANCE TEST RESULTS.
  - J. CONSTRUCTION AND POST CONSTRUCTION TESTING: ADDITIONAL TESTING MAY BE REQUIRED BY LEED AND OTHER PROCESSES THAT MAY OCCUR OUT OF SEQUENCE WITH COMMISSIONING SERVICE. CONTRACTOR SHALL CONDUCT, DOCUMENT, SUPPORT AND SCHEDULE THIS TESTING AS DIRECTED BY STARBUCKS CXA.

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Revision Schedule			
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SHEET TITLE:  
**GREENER STORE INFORMATION**  
 SCALE: NO SCALE

SHEET NUMBER:  
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### PRE-APPROVED LIST FOR LOW EMMITING MATERIALS

#### MANUFACTURER - PRODUCT VOC CONTENT

ABS WELDING ADHESIVE	LIMIT 325 g/L
IPS CORPORATION - WELD-ON 2771 AND 2773 - ABS PIPE CEMENT	325 g/L
IPS CORPORATION - WELD-ON 773 - ABS PIPE CEMENT	<325 g/L
OATEY - LO-VOC ABS BLACK SOLVENT CEMENT	325 g/L

#### CARPET ADHESIVE LIMIT 50 g/L

HB FULLER - TEC 749 RELEASE PRESS	0 g/L
MAPEI - ULTRABOND ECO 120	43 g/L
MAPEI - ULTRABOND ECO 800	0 g/L
ROBERTS - 6700 SUPERIOR	0 g/L

#### CERAMIC TILE ADHESIVE LIMIT 65 g/L

DUPONT SURFACES - CORIAN SOLID SURFACES JOINT ADHESIVE	<50 g/L
LATICRETE - 252 SILVER	0 g/L
LATICRETE - 254 PLATINUM	0.5 g/L
LATICRETE - 255 MULTIMAX	0 g/L
LATICRETE - 317 THIN SET	2.5 g/L
MAPEI - KERABOND	0 g/L
MAPEI - KERASET	0 g/L
MAPEI - PLANIPATCH	0 g/L
MAPEI - PLANIPATCH PLUS	53 g/L
MAPEI - TYPE 1	60 g/L
MAPEI - ULTRAFLEX 1	0 g/L
MAPEI - ULTRAFLEX 2	0 g/L
MAPEI - ULTRAFLEX S2 MONO	<12 g/L
MAPEI - ULTRAMASTIC ECO	57 g/L
RAECO - R-2000 BONDING AGENT	2.5 g/L

#### CONTACT ADHESIVE LIMIT 80 g/L

3M - FASTBOND CONTACT ADHESIVE	77 g/L
HENKEL - LEPAGE CONTACT CEMENT	<10 g/L
HENKEL - LEPAGE PRES-TITE GREEN CONTACT CEMENT	<10 g/L

#### CPVC ADHESIVE LIMIT 490 g/L

OATLEY - HEAVY DUTY CPVC ORANGE SOLVENT CEMENT	77 g/L
OATLEY - FLOWGUARD GOLD ALL WEATHER 1 STEP SOLVENT CEMENT	<10 g/L

#### DRYWALL AND PANEL ADHESIVE LIMIT 50 g/L

DATENBLATT_A814 - PART A AND B	0 g/L
FRANKLIN INTERNATIONAL - MARLITE C-551	2.6 g/L
FRANKLIN INTERNATIONAL - TITEBOND SOLVENT FREE FAST GRAB	2.6 g/L
LIQUID NAILS - FRP - 310	34 g/L
GREEN GLUE COMPANY - GREEN GLUE	<5 g/L
ROMAN - PRO-774	0 g/L

#### MULT-PURPOSE CONSTRUCTION ADHESIVE LIMIT 70 g/L

3M - SCOTCH-WELD URETHANE ADHESIVE DP-620NS, BLACK	<10 g/L
ELMER'S - CARPENTER'S INTERIOR WOOD GLUE	<1 g/L
EVERBUILD - GUN A NAIL STANDARD	25.3 g/L
FRANKLIN INTERNATIONAL - TITEBOND III WOOD GLUE	5.6 g/L
HENKEL - LEPAGE CARPENTER'S GLUE	<2 g/L
HENKEL - LEPAGE EPOXY RESIN	.38 g/L
HENKEL - LEPAGE PL PREMIUM	45 g/L
LIQUID NAILS - LN 704	22 g/L
LIQUID NAILS - LN 903	<70 g/L
ROMAN - PRO-838	17.2 g/L
ROMAN - PRO-880	<50 g/L
ROMAN - PRO-935	8 g/L
SIKA - SIKABOND	48.3 g/L

### PRE-APPROVED LIST FOR LOW EMMITING MATERIALS

#### MANUFACTURER - PRODUCT VOC CONTENT

PVC WELDING	LIMIT 510 g/L
IPS CORPORATION - IPEX SYS 15 GREY	<510 g/L
IPS CORPORATION - WELD_ON 782 CLEAR CEMENT FOR PVC	<510 g/L
IPS CORPORATION - WELD-ON 711 LOW VOC PIPE CEMENT	<510 g/L
IPS CORPORATION - WELD-ON 780 CLEAR CEMENT FOR PVC	<510 g/L
IPS CORPORATION - WELD-ON 781 CLEAR CEMENT FOR PVC	<510 g/L
IPS CORPORATION - WELD-ON 781 GREY CEMENT FOR PVC	<510 g/L
IPS CORPORATION - WELD-ON 810 - 2 COMPONENT ADHESIVE	50 g/L
IPS CORPORATION - WELD-ON DUIT 413 - PVC PIPE CEMENT	510 g/L
OATEY - CLEAR ADVANCED PVC CEMENT	<510 g/L
TIGRE - ADESIVO AQUATHERM (AQUATHERM E ESPECIAL) CPVC	330 g/L
TIGRE - ADESIVO PLASTICO PARA PVC - INCOLOR	332.14 g/L

#### ADHESIVE PRIMER FOR PLASTIC LIMIT 550 g/L

IPS CORPORATION - WELD-ON PLUMBING CLEAR PRIMER FOR PVC	550 g/L
IPS CORPORATION - WELD-ON PLUMBING PURPLE PRIMER FOR PVC	550 g/L
OATLEY - PURPLE PRIMER NSF LISTED	550 g/L

#### SPECIAL PURPOSE AEROSOL ADHESIVE LIMIT 70% BY WEIGHT

IPS CORPORATION - WELD-ON PLUMBING CLEAR PRIMER FOR PVC	64%
---	-----

#### SUBFLOOR ADHESIVE LIMIT 50 g/L

FRANKLIN INTERNATIONAL - GREENCHOICE WEATHERPROOF SUBFLOOR ADHESIVE (TITEBOND)	550 g/L
HENKEL - OSI PRO SERIES 450 SUBFLOOR ADHESIVE	<2 g/L

#### VCT ADHESIVE LIMIT 50 g/L

BALL - STYCCIBOND F44	48 g/L
ROMAN - VOV 11901	5 g/L
ROMAN - VOV 11905	5 g/L

#### WOOD FLOORING ADHESIVE LIMIT 100 g/L

ARMSTRONG WORLD INDUSTRIES - EVERLAST PREMIUM URETHANE	77 g/L
ARMSTRONG WORLD INDUSTRIES - HARTCO 57 WOOD FLOORING - URETHANE	65 g/L
ARMSTRONG WORLD INDUSTRIES - PROCONNECT WOOD FLOORING - ACRYLIC	7 g/L
HENKEL - LOCTITE PL400 SUBFLOOR ADHESIVE	5.2 g/L
SIKA CORPORATION - SIKABOND-T54 - URETHANE	30.38 g/L
SIKA CORPORATION - SIKABOND-T55 - URETHANE	83 g/L

#### ARCHITECTURAL SEALANT LIMIT 250 g/L

3M - FIRE BARRIER CP-25WB+	<1 g/L
3M - FIRE BARRIER MOLDABLE PUTTY+	0 g/L
BALL - STOPGP P131 PRIMER	15 g/L
BASF - SONOLASTIC	<100 g/L
CERTAINTEEED - PROROC READY-MIX JOINT COMPOUND	0 g/L
CUSTOM BUILDING PRODUCTS - POLYBLEND SANDED GROUT	0 g/L
DAP - ALEX PAINTER'S ACRYLIC LATEX CAULK - ALL COLORS	59.2 g/L
DAP - ALEX PLUS ACRYLIC LATEX CAULK SILICONE - CLEAR	44.4 g/L
DAP - DYNAFLEX 230	49 g/L
DAP - KWIK SEAL TUB & TILE CAULKING - ALL COLORS	25.4 g/L
DAP - SILICONE PLUS RUBBER KITCHEN & BATH SEALANT	<40 g/L
DATENBLATT - PCI ZEMTEC 1K	.015 g/L
DATENBLATT - MAPESIL AC	26 g/L
DESIGN POLYMERICS - 1010 WATER BASED DUCT SEALANT	0 g/L
DESIGN POLYMERICS - 1020 WATER BASED DUCT SEALANT	0 g/L
DESIGN POLYMERICS - 1030 WATER BASED DUCT SEALANT	0 g/L
DOW CORNING - 732 SILICONE	35 g/L
DOW CORNING - 786 SILICONE	33 g/L
DOW CORNING - HVAC/R SILICONE	33 g/L
DYE-N-SEAL-DECORATIVE CONCRETE DYE	0 g/L

### PRE-APPROVED LIST FOR LOW EMMITING MATERIALS

#### MANUFACTURER - PRODUCT VOC CONTENT

ARCHITECTURAL SEALANT	LIMIT 250 g/L
DUCTMATE INDUSTRIES - PRO SEAL	41 g/L
EUCLID CHEM CO - CLEARSEAL WB 150	134 g/L
GE - SILICONE SEALANT	20 g/L
GRABBER - GRABBERGARD EFC	32.5 g/L
HAMILTON DRYWALL PRODUCTS - POWDERED JOINT CEMENT	0 g/L
HARDCAST CARLISLE - DUCTSEAL 321	75 g/L
HARDCAST CARLISLE - IRONGRIP 601	49 g/L
HENKEL - OSI PRO-SERIES	<50 g/L
HERCULES - STAY PUT PUTTY	0 g/L
IDEAL CHEMICAL PRODUCTS - IDEALSEAL UNIVERSAL SILICONE	0 g/L
IPS - WELD-ON ALL SEAL PIPE JOINT COMPOUND	0 g/L
LATICRETE - 1600 SANDED GROUT	0 g/L
LATICRETE - 1600 UNSANDED GROUT	0 g/L
LATICRETE - LATASIL SILICONE	37.16 g/L
LATICRETE - PERMACOLOR GROUT	0 g/L
LATICRETE - PREMIUM ACRYLIC CAULK	50 g/L
LATICRETE - SPECTRALOCK	.031 g/L

#### ARCHITECTURAL SEALANT LIMIT 250 g/L

MAPEI - KERACAULK S	41 g/L
MAPEI - KERACOLOR S	0 g/L
MAPEI - KERACOLOR U	0 g/L
MAPEI - KERALASTIC MORTAR	0 g/L
MAPEI - KERAPLY	3 g/L
MAPEI - KERAPOXY - PART A	7 g/L
MAPEI - KERAPOXY IEG - PART A	21 g/L
MAPEI - ULTRACOLOR PLUS	0 g/L
MAPEI - ULTRACONTACT	0 g/L
MAPEI - ULTRAFLEX LFT	0 g/L
MAPEI - ULTRALITE MORTAR	0 g/L
MAPEI - ULTRALITE MORTAR PRO	0 g/L
MOMENTIVE - SCS1000 SILICONE SEALANT	20 g/L
MOMENTIVE - SILICONE RUBBER SEALANT	27 g/L
NATIONAL GYPSUM - READY MIX JOINT COMPOUNDS - PROFORM (MULTIPLE PRODUCTS)	2 g/L
NR4000 - WHITE LIGHTNING SILICONIZED ACRYLIC LATEX CAULK	43 g/L
OATEY - GREAT WHITE PJC	3 g/L
OATEY - PLUMBERS PUTTY	0 g/L
PCI SECCORAL 1 K	1.5 g/L
POLYMER ADHESIVE - AIRSEAL #22	<21 g/L
POLYMER ADHESIVE - AIRSEAL #33	35 g/L
REDGARD - F 1051	5 g/L
RIGIPS - SUPER FUGENFULLER JOINT COMPOUND	0.009 g/L
SICHERHEITSDATENBLATT - BRILLUX ACRYLIC SEALANT 395	20 g/L
SICHERHEITSDATENBLATT - BRILLUX AIRLESS-SPACHTEL 1890	1 g/L
SICHERHEITSDATENBLATT - BRILLUX RIGIPS	0.0009 g/L
SICHERHEITSDATENBLATT - BRILLUX CREAGLAS ELF 377	1 g/L
SICHERHEITSDATENBLATT - BRILLUX UNIFLOTT 6 JOINT COMPOUND	0 g/L
SICHERHEITSDATENBLATT - BRILLUX UNIFLOTT 8 JOINT COMPOUND	0 g/L
SIKAGARD - HIGH GLOSS CLEAR SEALER	<20 g/L
SOLOCROM - JUNTA PLAC MASILLA	3 g/L
SONNEBORN, DIVISION OF BASF - OMNI-PLUS	0 g/L
SONNEBORN, DIVISION OF BASF - SONOLAC	41 g/L
SOUDAL - FIX ALL CLASSIC	33.4 g/L
SPECSEAL - SERIES SSS INTUMESCENT SEALANT	22 g/L
TITEBOND - PAINTER'S PLUS CAULK - CLEAR	28 g/L
TITEBOND - PAINTER'S PLUS CAULK - WHITE OR COLORS	33 g/L
TREMCO - TREMFLEX 834 - WHITE	22 g/L
TREMCO - TREMSIL 200 - CLEAR	1 g/L
TREMCO - TREMSTOP ACRYLIC	35 g/L

### PRE-APPROVED LIST FOR LOW EMMITING MATERIALS

#### MANUFACTURER - PRODUCT VOC CONTENT

ARCHITECTURAL SEALANT	LIMIT 250 g/L
USG - FIRECODE COMPOUND	<2 g/L
USG (US GYPSUM CO) - BEADEX ALL PURPOSE DRYWALL	<2 g/L
USG (US GYPSUM CO) - BEADEX LITE TAPING DRYWALL	<2 g/L
USG (US GYPSUM CO) - SHEETROCK ALL PURPOSES JOINT COMPOUND	0 g/L
VERSAFLEX, INC. - SL/45 PART B (HARDNER)	0 g/L
VERSAFLEX, INC. - SL/45 PART B (PRE-POLYMER)	0 g/L
W R GRACE - FLAMESAFE FS 1900 FIRESTOP	10.86 g/L
WESTPAC MATERIALS - FAST SET 20 - DRYWALL JOINT AND PATCHING COMPOUND	0 g/L
WESTPAC MATERIALS - FAST SET 40 - DRYWALL JOINT AND PATCHING COMPOUND	0 g/L
WESTPAC MATERIALS - FAST SET LITE 5 - DRYWALL JOINT AND PATCHING COMPOUND	0 g/L
WESTPAC MATERIALS - ECO SET LITE 20 - DRYWALL JOINT AND PATCHING COMPOUND	0 g/L
WESTPAC MATERIALS - ECO SET LITE 40 - DRYWALL JOINT AND PATCHING COMPOUND	0 g/L
WESTPAC MATERIALS - ECO SET LITE 90 - DRYWALL JOINT AND PATCHING COMPOUND	0 g/L

#### ARCHITECTURAL PAINTS/COATINGS/PRIMER - FLATS LIMIT 50 g/L

C2 - L-8000 LOVO INTERIOR LATEX NON-REFLECTIVE FLAT	<50 g/L
ICI - DULUX	30 g/L
SHERWIN-WILLIAMS - HARMONY INTERIOR LATEX PRIMER	0 g/L
SHERWIN-WILLIAMS - PROMAR LATEX PRIMER	0 g/L

#### ARCHITECTURAL PAINTS/COATINGS/PRIMER - NON-FLATS LIMIT 150 g/L

BRILLUX - PM 270	<100 g/L
BRILLUX - ACYL-FASSADENFARBE	25 g/L
BRILLUX - LF595	1 g/L
BRILLUX - PM246	<100 g/L
C2 - L1800 LOVO WALLBOARD PRIMER	<50 g/L
C2 - L8200 LOVO INTERIOR LATEX EGG SHELL	<50 g/L
C2 - L8400 LOVO INTERIOR LATEX SEMI-GLOSS	<50 g/L
ICI - DULUX ECOSURE WATER-BASED GLOSS	75 g/L
ICI - DULUX LIFEMASTER EGG SHELL INTERIOR LATEX ENAMEL	0 g/L
ICI - DULUX LIFEMASTER SEMI-GLOSS INTERIOR LATEX ENAMEL	0 g/L
SHERWIN-WILLIAMS - COLORACCENTS, EGG SHELL	126 g/L
SHERWIN-WILLIAMS - DTM ACRYLIC PRIMER	132 g/L
SHERWIN-WILLIAMS - ECOSELECT ZERO VOC EGG SHELL LATEX	0 g/L
SHERWIN-WILLIAMS - ECOSELECT ZERO VOC INTERIOR LATEX EGG SHELL	<40 g/L
SHERWIN-WILLIAMS - HARMONY INTERIOR LATEX PRIMER	0 g/L
SHERWIN-WILLIAMS - HARMONY INTERIOR SEMI-GLOSS	<50 g/L
SHERWIN-WILLIAMS - HARMONY, EGG SHELL	<50 g/L
SHERWIN-WILLIAMS - PRO INDUSTRIAL PRO-CRYL ACRYLIC PRIMER	96 g/L
SHERWIN-WILLIAMS - PROMAR200 PRIMER	91 g/L
SHERWIN-WILLIAMS - PROMAR400 LATEX EGG SHELL, EXTRA WHITE	0 g/L
SHERWIN-WILLIAMS - PROMAR400 LATEX SEMI-GLOSS, EXTRA WHITE	0 g/L

#### ANTICORROSIVE/ANTIRUST PAINT LIMIT 250 g/L

CAFCO - SPRAYFILM WB 4	0 g/L
ICI PAINTS - DEVOE DEVFLEX 4020PF	91 g/L
SHERWIN-WILLIAMS - WATER BASED CATALYZED EPOXY	120 g/L

#### CLEAR WOOD FINISHES - VARNISH LIMIT 350 g/L

SHERWIN-WILLIAMS - WOOD CLASSICS WATERBORNE POLYURETHANE VARNISH	311 g/L
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#### FLOOR COATINGS LIMIT 100 g/L

MAPEI - MAPECEM QUICKPATCH	0 g/L
ADVANCED FLOOR PRODUCTS - RETROPLACE 99	0 g/L

REVIEWED FOR CODE COMPLIANCE  
Wagne Thorne - PX3005 11-09-23  
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STARBUCKS TEMPLATE VERSION: I2021-09-13

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FOR CONSTRUCTION



PROJECT NAME:  
**US 17-92 & LAKE MARY BLVD**

PROJECT ADDRESS:  
**3764 ORLANDO DRIVE  
SANFORD, FL 32773**

STORE #: 81065  
PROJECT #: 98504-001  
ISSUE DATE: 08-03-2023  
DESIGNER: PAULINA LOPEZ  
PRODUCTION DESIGNER: ANDY MCLLOUD  
CHECKED BY: DONALD RETHMAN

Revision Schedule			
Rev	Date	By	Description

SHEET TITLE:  
**PRE-APPROVED CONST. MATERIALS**  
SCALE: NO SCALE

SHEET NUMBER:  
**G-006**

**PRE-APPROVED LIST FOR LOW EMMITING MATERIALS**

MANUFACTURER - PRODUCT VOC CONTENT	
<b>WATERPROOFING SEALERS</b>	<b>LIMIT 250 g/L</b>
ADVANCED FLOOR PRODUCTS - RETROGUARD	100 g/L
AMERIPOLISH - PROGUARD STAIN SHIELD	<50 g/L
DEVOE - WATERBORNE EPOXY	200 g/L
H&C - CONCRETE SEALER	250 g/L
MAPEI - MAPELASTIC AQUADEFENSE	0 g/L
SCOFIELD - FORMULA ONE	0 g/L
SCOFIELD - FORMULA ONE FINISH COAT	0 g/L
SCOFIELD - FORMULA ONE GUARD-W	<100 g/L
SCOFIELD - FORMULA ONE DYE	10.7 g/L
SCOFIELD - FORMULA ONE LITHIUM DENSIFIER	0 g/L
SEALSOURCE - KROMAPOLISH	0 g/L
<b>STAINS</b>	<b>LIMIT 250 g/L</b>
H&C - CONCRETE STAIN	246 g/L
AMERIPOLISH - COLOR JUICE COATING	0 g/L
DALYS - WOODBORNE WOOD STAIN	<50 g/L
<b>CARPET</b>	
INTERFACEFLOR - GLP	CRI GREEN LABEL
INTERFACEFLOR - SOFTSISAL	CRI GREEN LABEL
LEES CARPET TILE - GROUND STRATA MODULAR	CRI GREEN LABEL
SHAW INDUSTRIES - VIBE	CRI GREEN LABEL

**PRE-APPROVED LIST FOR LOW EMMITING MATERIALS**

MANUFACTURER - PRODUCT VOC CONTENT	
<b>HARD SURFACE FLOORING</b>	
NON-ORGANIC GLAZED TILE - GENERIC (ALL NON-ORGANIC, GLAZED TILE COMPLIES)	N/A
ALTRO LTD - STRONGHOLD 30	FLOORSCORE
ALTRO LTD - AQUARIUS	FLOORSCORE
ALTRO LTD - ATLAS 40	FLOORSCORE
ALTRO LTD - CONTRAX	FLOORSCORE
ALTRO LTD - DESIGNER 25	FLOORSCORE
ALTRO LTD - IMPRESSIONIST II	FLOORSCORE
ALTRO LTD - MARINE 20	FLOORSCORE
ALTRO LTD - MAXIS 25	FLOORSCORE
ALTRO LTD - MIRICA	FLOORSCORE
ALTRO LTD - SUPREMA II	FLOORSCORE
ALTRO LTD - TIMBERSAFE II	FLOORSCORE
ALTRO LTD - WALKWAY 20	FLOORSCORE
ALTRO LTD - WALKWAY 20D	FLOORSCORE
ALTRO LTD - XPRESSLAY	FLOORSCORE
CROSSVILLE INC - AMERCANO	FLOORSCORE
CROSSVILLE INC - BLUESTONE	FLOORSCORE
CROSSVILLE INC - BUILDING BLOX	FLOORSCORE
CROSSVILLE INC - CLASSIC MOSAICS	FLOORSCORE
CROSSVILLE INC - COLOR BLOX EC	FLOORSCORE
CROSSVILLE INC - COLOR BLOX MOSAICS	FLOORSCORE
CROSSVILLE INC - COLOR BLOX TOO	FLOORSCORE
CROSSVILLE INC - COTTO AMERICANA	FLOORSCORE
CROSSVILLE INC - CROSS COLORS	FLOORSCORE
CROSSVILLE INC - CROSS COLORS LP	FLOORSCORE
CROSSVILLE INC - ECOCYCLE	FLOORSCORE
CROSSVILLE INC - MAIN STREET	FLOORSCORE
CROSSVILLE INC - PALAIS	FLOORSCORE
CROSSVILLE INC - POMPEII	FLOORSCORE
CROSSVILLE INC - RETRO ACTIVE	FLOORSCORE
CROSSVILLE INC - STRUCTURE	FLOORSCORE
CROSSVILLE INC - TEXTURES	FLOORSCORE
CROSSVILLE INC - TUSCAN CLAY	FLOORSCORE
CROSSVILLE INC - ULTIMETAL	FLOORSCORE
CROSSVILLE INC - VISTA AMERICANA	FLOORSCORE
CROSSVILLE INC - WEATHERSTONE	FLOORSCORE
CROSSVILLE INC - WOOD IMPRESSIONS	FLOORSCORE

**PRE-APPROVED LIST FOR LOW EMMITING MATERIALS**

MANUFACTURER - PRODUCT VOC CONTENT	
<b>COMPOSITE WOOD</b>	<b>NO ADDED UREA-FORMALDEHYDE</b>
ANY - APA RATED STRUCTURAL PLYWOOD (EXPOSURE 1 OR EXTERIOR)	YES
COLUMBIA FOREST PRODUCTS - EUROPLY PLUS	YES
COLUMBIA FOREST PRODUCTS - PUREBOND	YES
EGGERS INDUSTRIES - 206 5-PLY	YES
GLASTEEL - GLASLINER - FRP	YES
GRAHAM WOOD DOORS - GPD-45 5-PLY AGRIFIBER	YES
GRAHAM WOOD DOORS - GPD-AP 5-PLY AGRIFIBER	YES
GRAHAM WOOD DOORS - GPD-EC 5-PLY ENGINEERED COMPOSITE	YES
GRAHAM WOOD DOORS - GPD-SL 5-PLY STAVE LUMBER	YES
LYDEN DOORS - CD200 NAUF PARTICLEBOARD CORE	YES
LYDEN DOORS - CD250 AGFIBER CORE	YES
LYDEN DOORS - CD300 NAUF STAVE LUMBER CORE	YES
LYDEN DOORS - CD350 STRUCTURAL COMPOSITE CORE	YES
MARSHFIELD - ENVIRONMENTAL CLASS	YES
NAUF - COMPOSITE WOOD DOOR	YES
ROSEBURG - COMPOSITE WOOD PANTLS	YES
SIERRA PINE - ARREIS	YES
SIERRA PINE - MEDEX	YES
SIERRA PINE - MEDITE FR	YES
SIERRA PINE - MEDITE II	YES
SIERRA PINE - PERMACORE	YES
<b>GYPSON BOARD</b>	
AMERICAN GYPSUM - FIREBLOCK	GREENGUARD GOLD
GEORGIA PACIFIC - TOUGHROCK FIREGUARD	GREENGUARD GOLD
LAFARGE - FIRECHECK	GREENGUARD GOLD
NATIONAL GYPSUM - GOLD BOND FIRESHIELD	GREENGUARD GOLD
CERTAINTED - PROROC TYPE X	CHPS
USG - SHEETROCK FIRECODE	CHPS
GEORGIA PACIFIC - TOUGHROCK GYPSUM BOARD	GREENGUARD GOLD
SMDS - DENSARMOR PLUS	GREENGUARD GOLD
<b>ACOUSTICAL CEILING SYSTEM</b>	
ARMSTRONG - CERAMAGUARD	CHPS
ARMSTRONG - FINE FISSURED	CHPS
ARMSTRONG - CLEANROOM VL	CHPS
ARMSTRONG - CORTEGA	CDPH/EHLB
ARMSTRONG - CLEANROOM	CDPH/EHLB
CRANE - SEQUENTIA LAMINATED PANELS	GREENGUARD
ARMSTRONG - METALWORKS	CHPS
USG - RADAR	CHPS/CDPH/EHLB
USG - SHEETROCK	CA/DHS/EHLB
<b>WALL COVERINGS</b>	
CERTAINTED - DIAMONDBACK TILE BACKER	GREENGUARD GOLD
COLUMBIA FOREST PRODUCTS - EUROPLY PLUS	NAUF
COLUMBIA FOREST PRODUCTS - PUREBOND	NAUF
CRANE COMPOSITES - GLASBORD FRP	GREENGUARD GOLD
DAL-TILE - CERAMIC WALL TILE	CHPS
GEORGIA PACIFIC - DENSSHIELD TILE BACKER BOARD	CHPS
GLASTEEL - GLASLINER FRP	GREENGUARD GOLD
MARLITE - FRP	GREENGUARD
NATIONAL GYPSUM - E2XP TILE BACKER	GREENGUARD GOLD
OMNOVA - ECORE	GREENGUARD GOLD
PANOLAM INDUSTRIES - PANOLAM FRP	GREENGUARD GOLD
PARKLAND PLASTICS - PLASTEX NRP	GREENGUARD GOLD
SEQUENTIA - EMBOSSED TEXTURE	GREENGUARD

REVIEWED FOR CODE COMPLIANCE  
 Wayne Thorne - PX3005 11-09-23  
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 PRODUCTION DESIGNER: ANDY MCLLOUD  
 CHECKED BY: DONALD RETHMAN

Revision Schedule			
Rev	Date	By	Description

SHEET TITLE:  
**PRE-APPROVED CONST. MATERIALS**  
 SCALE: NO SCALE

SHEET NUMBER:  
**G-007**

WALL CONSTRUCTION SCHEDULE	
<b>WALL LABELING KEY:</b> INTERIOR SHEATHING WALL STUD → Xx X xx INTERIOR MODIFIER →	
<b>WALL STUD</b>	
4a	3 5/8" 20 GA STUDS AT 16" O.C. (FULL HEIGHT)
4b	3 5/8" 20 GA STUDS AT 16" O.C. (TERMINATE 6" ABOVE CEILING). PROVIDE 45 DEGREE METAL STUD BRACING AT 48" O.C. FROM TOP OF STUD WALL TO STRUCTURE ABOVE.
4c	3 5/8" 16 GA STUDS AT 16" O.C. (PARTIAL HEIGHT). DRYWALL SCREWS AT 12" O.C.
6a	6" 20 GA STUDS AT 16" O.C. (FULL HEIGHT)
<b>INTERIOR SHEATHING</b>	
A	BOTH SIDES 5/8" MOISTURE RESISTANT GYP. BOARD (ONE SIDE UNDERSIDE OF GYPSUM BOARD CEILING AND OTHER SIDE TERMINATE 6" ABOVE ACT CEILING)
B	BOTH SIDES 5/8" MOISTURE RESISTANT GYP. BOARD (BOTH SIDES TERMINATE 6" ABOVE ACT CEILING)
C	BOTH SIDES 5/8" MOISTURE RESISTANT GYP. BOARD (ONE SIDE TERMINATE 6" ABOVE ACT CEILING AND OTHER SIDE UP TO STRUCTURE)
D	BOTH SIDES 5/8" MOISTURE RESISTANT GYP. BOARD (BOTH SIDES UNDERSIDE OF GYPSUM BOARD CEILING)
E	BOTH SIDES 5/8" MOISTURE RESISTANT GYP. BOARD. (UP TO 4' - 0" AFF)
<b>INTERIOR MODIFIERS</b>	
ai	ACOUSTIC INSULATION (FULL HEIGHT)
48	PARTIAL HEIGHT WALL 48" AFF. 16 GA METAL STUDS AT 16" O.C. W/ RCKW RIGID CONNECTORS AT FLOOR. (MODIFIER = HEIGHT IN INCHES A.F.F.)

WALL BLOCKING KEY				
SYMBOL	ITEM	WEIGHT	HEIGHT A.F.F.	APPROX. WIDTH
A	WORKROOM HAND SINK	128 LBS (58 KG)	36" TO 40" (915MM TO 1015MM)	30" (760MM) BEHIND SINK
B	SHELVES ABOVE COMPARTMENT SINK	200 LBS (91 KG)	48" TO 76" (1220MM TO 1930MM)	96" (2440MM) CENTERED ABOVE COMPARTMENT SINK
C	RESTROOM GRAB BARS	200 LBS (91 KG)	30" TO 36" (760MM TO 915MM)	60" (1525MM) AROUND WATER CLOSET
D	SHELVES AT MANAGER'S DESK	300 LBS (136 KG)	32" TO 96" (810MM TO 2440MM)	48" (1220MM) 3/4 (19MM) ACX PLYWOOD, CENTERED ON SHELVES
E	EQUIPMENT RACK AT MANAGER'S DESK	300 LBS (136 KG)	44" TO 96" (1120MM TO 2440MM)	28" (710MM) 3/4 (19MM) ACX PLYWOOD, CENTERED ON RACK
F	WATER FILTRATION SYSTEM	TBD BY VENDOR		COORDINATE LOCATION AND EXTENT WITH PENTAIR
G	RESTROOM HAND SINK	200 LBS (91 KG)		COMMERCIAL INSTALLATION REQUIRES CONCEALED ARM CARRIER. REFER TO MFR'S SPECIFICATION.
H	UPPER CBE SHELVING		BLOCKING SPECIFICATION FOR CBE METAL SHELVES. REFER TO VENDOR'S SPECIFICATION AND DETAILS.	
I	5-COMP LOCKERS	200LBS	0" TO 66" (0MM TO 1676MM)	SEE PLAN
J	MILLWORK BOXES		BLOCKING SPECIFICATION FOR FRENCH CLEATING SYSTEM. REFER TO DETAILS.	
K	RESTROOM HAND DRYER	200LBS	36" TO 48" (915MM TO 1219MM)	24" STARTING 18" FROM WALL CORNER/SEE PLAN
L	ALL ARTWORK, FIXTURES, ACCESSORIES AND CASEWORK FABRICATIONS NOT OTHERWISE NOTED	TBD BY VENDOR (VARIES)	GC TO PROVIDE WALL BLOCKING AS REQUIRED FOR ALL ITEMS FOR A COMPLETE AND SECURE INSTALLATION. EXTEND BLOCKING 8" (205MM) BEYOND ON EACH SIDE OF EACH ITEM.	
M	ADAPTABLE CASEWORK	TBD BY VENDOR (VARIES)	BLOCKING SPECIFICATION FOR ADAPTABLE CASEWORK. REFER TO VENDOR'S SPECIFICATION AND DETAILS.	

LEGEND	
	NEW FULL HEIGHT WALL
	NEW PARTIAL HEIGHT WALL
	EXISTING WALL
	WALL BLOCKING CALL OUT

**REVIEWED FOR CODE COMPLIANCE**  
 Wayne Thorne - PX3005 11-09-23  
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**SANFORD BUILDING DEPARTMENT**

**SITE COPY BC23-000692**



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 SEATTLE, WASHINGTON 98134  
 (206) 318-1575

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STARBUCKS TEMPLATE VERSION: I2021-09-13

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 Professional Engineer  
 License: 62078




**GENERAL NOTES**

- GENERAL CONTRACTOR TO VERIFY ALL DIMENSIONS AND NOTIFY STARBUCKS CONSTRUCTION MANAGER OF ANY DISCREPANCIES PRIOR TO CONSTRUCTION. ALL DIMENSIONS TO BE TAKEN FROM DESIGNATED DATUM POINT.
- GENERAL CONTRACTOR TO PROVIDE FIRE TREATED WOOD STUD BLOCKING, OR EQUIVALENT TO SUPPORT ANY WALL ATTACHMENT AND/OR SIGNAGE.
- IF EXISTING EXTERIOR ENTRANCE THRESHOLD EXCEEDS MINIMUM BARRIER FREE PROVISION OF THE CODE, REMOVE AND REPLACE WITH ACCESSIBLE THRESHOLD. RAISED THRESHOLDS AND FLOOR LEVEL CHANGES AT ACCESSIBLE DOORWAYS TO BE BEVELED WITH A SLOPE NO GREATER THAN 1:12.
- ALL DIMENSIONS ARE TO FINISHED FACE UNLESS SHOWN OR NOTED OTHERWISE.
- INSTALL MOISTURE RESISTANT GREEN BOARD ON BACKBAR WALL PER PROJECT MANUAL.
- ALL DOORS SHALL BE 32" (815MM) MINIMUM CLEAR OPENING WHEN OPENED TO 90 DEGREE POSITION UNLESS OTHERWISE NOTED.
- SEE SHEET A601 FOR EXTERIOR DOOR AND WINDOW SCHEDULES.
- STARBUCKS VENDOR TO PROVIDE DOOR HARDWARE COMPONENTS AND GC TO INSTALL.
- VERIFY ALL EXISTING DOORS, HARDWARE AND FRAMES MEET STARBUCKS AND/OR CODE REQUIREMENTS.
- PROVIDE FIRE EXTINGUISHERS AS NOTED ON THE APPROVED PLANS FROM THE CITY.
- SEE SHEET A-501 FOR BUILDING DETAILS.
- REFER TO SHEET I-106 FOR FLOOR FINISHES.


**KEYED NOTES**

- EXISTING STOREFRONT DOOR. GC TO ENSURE IN PROPER WORKING ORDER AND REPAIR AS NECESSARY. REPLACE HARDWARE AS REQUIRED.
- EXISTING STOREFRONT WINDOW SYSTEM. GC TO CLEAN TO "LIKE NEW" CONDITION AND REPAIR AS NECESSARY.
- EXISTING 42IN SERVICE DOOR. GC TO ENSURE IN PROPER WORKING ORDER AND REPAIR AS NECESSARY. REPLACE HARDWARE AS REQUIRED.
- RECESSED ELECTRICAL PANEL. GC CONFIRM WITH WL AS INDICATED. MAINTAIN MINIMUM CLEARANCES AS REQUIRED BY CODE. REFER TO ELECTRICAL DRAWINGS.
- CONSTRUCT NEW 4' - 0" HIGH PARTIAL-HEIGHT WALL AS INDICATED. PROVIDE KNEE BRACE KIT #SKB AS MANUFACTURED BY PITCON INDUSTRIES @ 4' - 0" O.C. MAXIMUM FINISH ALL EXPOSED EDGES.
- INSTALL NEW DOORS AS INDICATED. SEE SHEET A-601 FOR DOOR AND HARDWARE TYPE.
- INSTALL DID#19458 DUSTED CRYSTAL WINDOW FILM ON INTERIOR FACE OF GLAZING. REFER TO SHEET I-101.1 FOR GRAPHICS SCHEDULE.
- SHELF FOR WATER HEATER ABOVE.
- FIRE EXTINGUISHER LOCATION.
- GC TO INSTALL REINFORCED CONCRETE FLOOR SLAB AND VAPOR BARRIER OVER EXISTING COMPACTED FILL. SEE SPECIFICATIONS.
- ALIGN FACE OF FINISHED WALL.
- EXISTING DT WINDOW.
- REFER TO SHEET A-601 FOR DOOR AND HARDWARE TYPE.

**NOTE:**  
 SEE SHEET A-501 & A-502 FOR WALL CONSTRUCTION DETAILS.

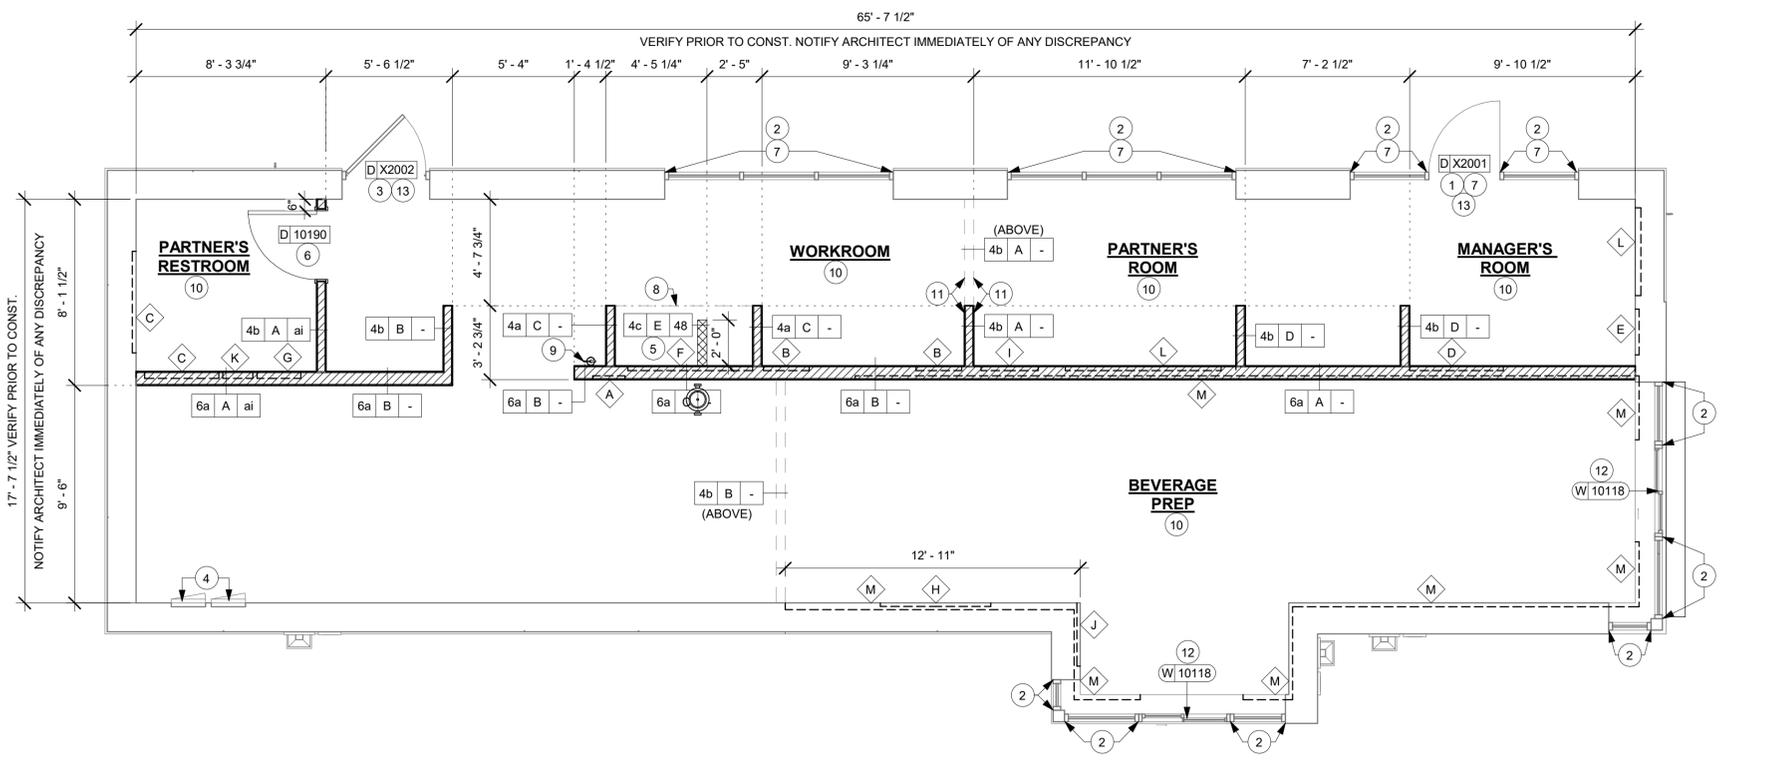

**1 BUILDING FLOOR PLAN**  
 Scale: 1/4" = 1'-0"

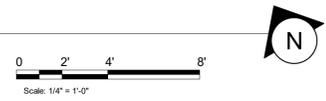

**FOR CONSTRUCTION**

PROJECT NAME:  
**US 17-92 & LAKE MARY BLVD**

PROJECT ADDRESS:  
**3764 ORLANDO DRIVE  
 SANFORD, FL 32773**

STORE #: 81065  
 PROJECT #: 98504-001  
 ISSUE DATE: 08-03-2023  
 DESIGNER: PAULINA LOPEZ  
 PRODUCTION DESIGNER: ANDY MCLLOUD  
 CHECKED BY: DONALD RETHMAN

Revision Schedule			
Rev	Date	By	Description

SHEET TITLE:  
**BUILDING FLOOR PLAN**

SCALE: 1/4" = 1'-0"

SHEET NUMBER:  
**A-101**

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**LEGEND**

-  FLOOR SINK
-  FLOOR PENETRATION
-  ELECTRICAL PENETRATION AREA
-  DATUM POINT
-  DRAIN FLOOR SINK (RESTROOMS)
-  WALL OUTLET

NOTE: SEE SHEET I-101.1 FOR PLUMBING FIXTURE SCHEDULE

REVIEWED FOR CODE COMPLIANCE  
 Wayne Thorne - PX3005 11-09-23  
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STARBUCKS TEMPLATE VERSION: I2021-09-13

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 Tel: (844) 804-7700  
 Timothy L. Raberding, PE  
 Professional Engineer  
 License: 62078



**FOR CONSTRUCTION**

PROJECT NAME:  
**US 17-92 & LAKE MARY BLVD**


PROJECT ADDRESS:  
**3764 ORLANDO DRIVE  
 SANFORD, FL 32773**

STORE #: 81065  
 PROJECT #: 98504-001  
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 CHECKED BY: DONALD RETHMAN


Revision Schedule			
Rev	Date	By	Description

SHEET TITLE:  
**BUILDING FLOOR PENETRATION PLAN**  
 SCALE: 1/4" = 1'-0"

SHEET NUMBER:  
**A-102**

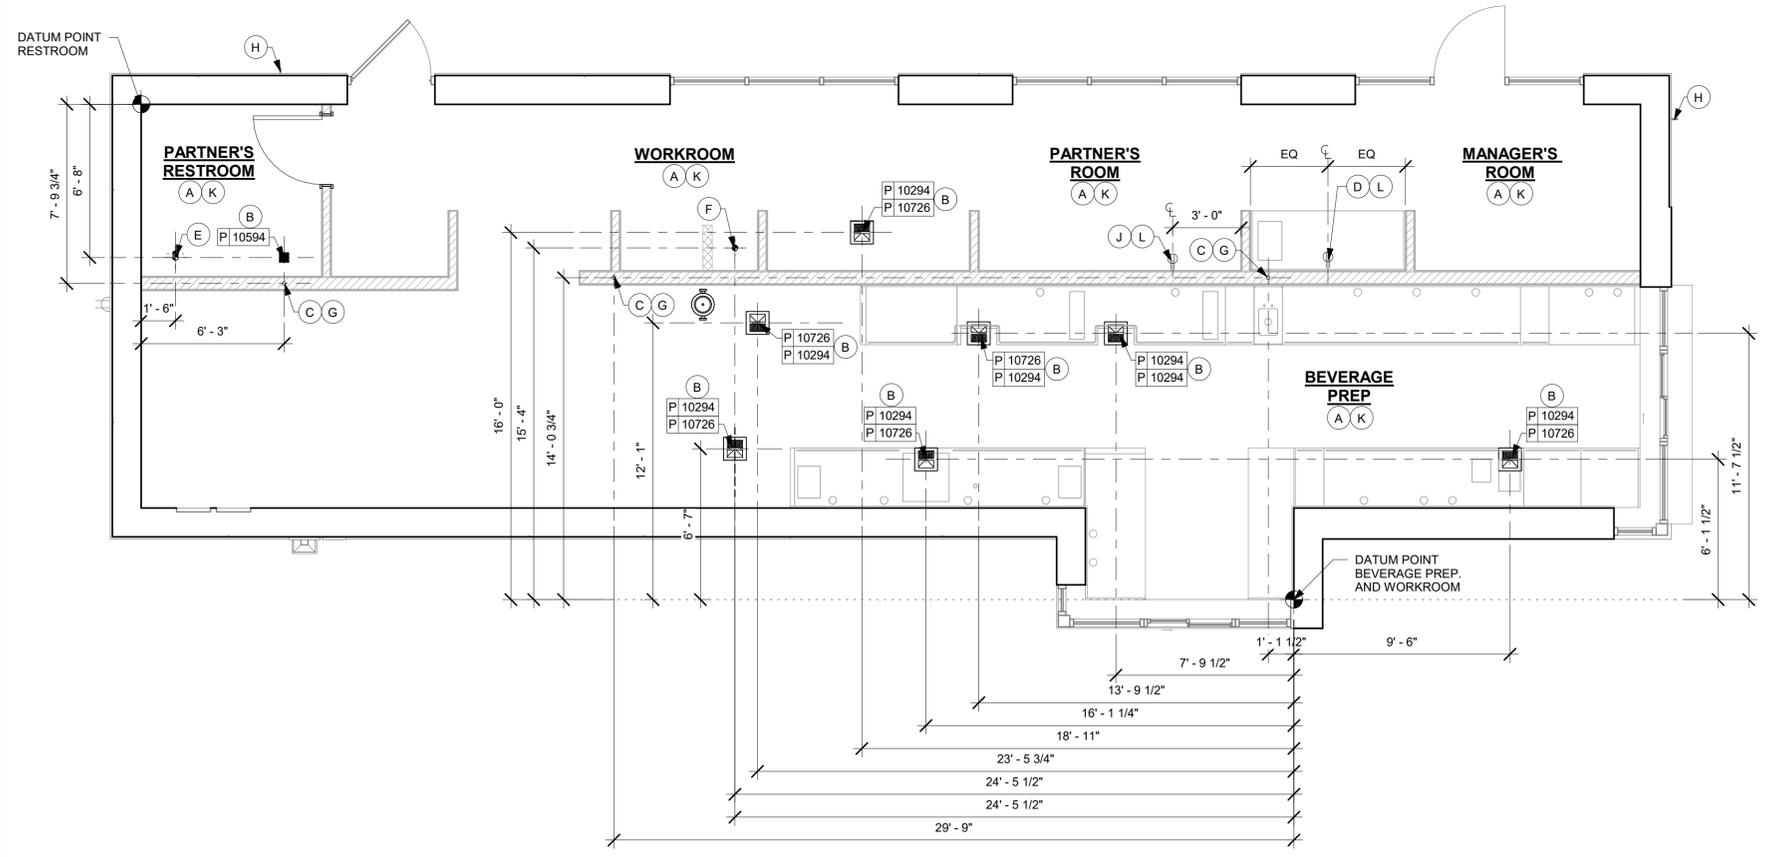

**1 BUILDING FLOOR PENETRATION PLAN**  
 Scale: 1/4" = 1'-0"

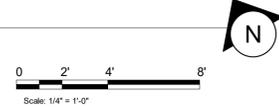

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CEILING TREATMENT SCHEDULE - "U"					
DESIGN ID	AREA	DESCRIPTION	FURN. BY	INST. BY	COMMENTS
OTHER					
19734	833 SF	ACT - ULTIMA - 2X2FT 61X61CM	GC	GC	FACTORY FINISHED SW7031 MEGA GREIGE; FOR ORDERING CONTACT DEB PICKENS AT DPLPICKENS@ARMSTRONGCEILINGS.COM, PH: 480-695-9053

PAINT SCHEDULE					
COLOR CODE	DESCRIPTION	LRV	FURN. BY	INST. BY	COMMENTS
SW6991-SG	SW - BLACK MAGIC - SEMIGLOSS	6	GC	GC	USE PRIMER CP-1
SW7031-ES	SW - MEGA GREIGE - EGG SHELL	37	GC	GC	USE PRIMER CP-1
SW7033-ES	SW - BRAINSTORM BRONZE - EGG SHELL	15	GC	GC	USE PRIMER CP-1
SW7033-SG	SW - BRAINSTORM BRONZE - SEMIGLOSS	15	GC	GC	USE PRIMER CP-1
SW7631-ES	SW - CITY LOFT - EGG SHELL	70	GC	GC	USE PRIMER CP-1

**LEGEND**

- ELEVATION DATUM
- TRACK LIGHTING
- PENDANT LIGHT
- RECESSED CAN LIGHT
- TROFFER
- WALL SCONCE
- EXIT SECURITY LIGHT
- MUSIC SYSTEM SPEAKER
- RECESSED SPEAKER
- WIFI ACCESS POINT (WAP)
- SECURITY CAMERA
- PIR MOTION SENSOR
- RR SCONCE

**LIGHTING LEGEND**

- CAN - CUSTOM RECESSED - BLACK - 1155LM WIDE FLOOD WITH DIMMER [LX7001]
- TRACK - LED FIXTURE WITH SNOOT - 3IN 75MM - BLACK - 1100LM FLOOD [L21779]

**GENERAL NOTES**

- A. IF REQUIRED BY LOCAL CODE, GENERAL CONTRACTOR TO PROVIDE SEMI-RECESSED SPRINKLER HEADS WITH POLISHED CHROME ESCUTCHEONS CENTERED IN ACOUSTICAL CEILING TILE. IF PENDANT HEADS ARE REQUIRED IN GWB SOFFIT OVER FRONTBAR, CONCEAL SUPPLY PIPING WITHIN SOFFIT. GENERAL CONTRACTOR TO SUBMIT SPRINKLER LAYOUT TO STARBUCKS' CONSTRUCTION MANAGER FOR APPROVAL PRIOR TO INSTALLATION.
- B. LEAVE TEN (10) ADDITIONAL RETAIL CEILING TILES TO MATCH RETAIL CEILING PAINT COLOR ABOVE THE WORKROOM CEILING AT MANAGER'S DESK FOR FUTURE USE.
- C. PROVIDE GROMMET AT ACOUSTIC CEILING PENETRATIONS FOR FIXTURES OF SUPPORTS.
- D. HEATING, VENTILATING AND AIR CONDITIONING SHOWN ON THIS PLAN PROVIDED FOR REFERENCE ONLY. SEE MECHANICAL DRAWINGS FOR ADDITIONAL INFORMATION.
- E. DIFFUSERS AND RETURNS IN ACOUSTICAL CEILING TILE TO BE CENTERED IN TILE AND PAINTED TO MATCH ADJACENT FINISHES (TYP.).
- F. PAINT ALL EXPOSED HVAC DUCTS, HVAC DIFFUSERS, LIGHT TRIM RINGS, PIPING, CONDUIT AND JUNCTION BOXES THE SAME COLOR AS SPECIFIED ON SURROUNDING CEILING OR SOFFIT UNLESS OTHERWISE NOTED. TYPICAL THROUGHOUT RETAIL AREA OF STORE.
- G. PAINT SUBSTITUTIONS ARE NOT ALLOWED. USE STARBUCKS' NATIONAL ACCOUNT "COLOR CODE" WHEN ORDERING PAINTS.
- H. THE DUCT MOUNTED SMOKE DETECTORS ARE TO BE CONNECTED TO THE EXISTING SYSTEM PROVIDED BY THE LANDLORD.

**RESPONSIBILITY LEGEND**

FURN. BY	INST. BY
SB - FURNISHED BY STARBUCKS	GC - INSTALLED BY GENERAL CONTRACTOR
GC - FURNISHED BY GENERAL CONTRACTOR	SB - INSTALLED BY STARBUCKS
VD - FURNISHED BY VENDOR	VD - INSTALLED BY VENDOR

**NOTE:** ALL RESPONSIBILITIES TO BE CONFIRMED WITH STARBUCKS CONSTRUCTION MANAGER PRIOR TO ORDERING / CONSTRUCTION.


REVIEWED FOR CODE COMPLIANCE  
 Wayne Thorne - PX3005 11-09-23  
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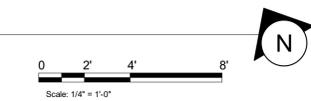
**BUILDING DEPARTMENT**  
**SANFORD**

**KEYED NOTES**

1. INSTALL 2' X 2' ACT CEILING TILE LOCATED IN WORKROOM AND ENGINE AREA AS INDICATED.
2. GYP. CEILING / SOFFIT WITH SMOOTH FINISH (PAINT AS SCHEDULED).
3. PAINT RECESSED LIGHTING TRIM TO MATCH CEILING AS CLOSELY AS POSSIBLE.
4. LINE OF HEADER.
5. ALIGN FINISHED SURFACES.
6. LOCATIONS OF ALL EGRESS LIGHTING FOR REFERENCE ONLY. GC TO VERIFY WITH LOCAL FIRE MARSHAL PRIOR TO INSTALLATION.
7. REFER TO INTERIOR FINISH ELEVATIONS FOR MENU BOARD SPACING.
8. REFER TO SHEET A-105 FOR LIGHTING LOCATIONS AND INFORMATION.
9. INSTALL EXTERIOR WALL MOUNTED SPEAKERS TIGHT TO CANOPY.
10. INSTALL RECESSED SPEAKERS AS INDICATED.(CENTER ON ACT WHERE APPLICABLE)
11. PLATFORM FOR HEATER AND WATER FILTRATION. PROVIDE SOFFIT AND LIFT CEILING THIS AREA ONLY TO ENSURE ADEQUATE CLEARANCE FOR SERVICING.
12. LOCATION OF ALL SWITCHING.
13. INSTALL EXTERIOR WALL MOUNTED PICK UP SIGN AS INDICATED.
14. INSTALL SECURITY CAMERA AS INDICATED.
15. WIRELESS ACCESS POINT: LOCATE (2) PER STORE, ONE ABOVE POS, ONE NEAR MANAGER'S WORKSTATION.
16. PER MOTION DETECTOR: MOTION DETECTORS ARE REQUIRED IN THE FOLLOWING LOCATIONS: (CENTRALLY LOCATE IN ZONES LISTED BELOW)  
 A. BEHIND BAR NEAR POINT OF SALE  
 B. AT MANAGER'S WORKSTATION  
 C. CENTRALLY LOCATED IN BACK OF HOUSE
17. EXTERIOR BUILDING SIGNAGE. SEE BUILDING EXTERIOR ELEVATIONS FOR ADDITIONAL INFORMATION.
18. EXISTING EXTERIOR WALL SCONCES.
19. EXISTING EXTERIOR SECURITY LIGHT.
20. EXISTING AWNING / CANOPY.
21. EXISTING EXTERIOR CANOPY RECESSED CAN LIGHTS.
22. INSTALL ROLLER SHADES AS INDICATED.



**REFLECTED CEILING PLAN**  
 Scale: 1/4" = 1'-0"

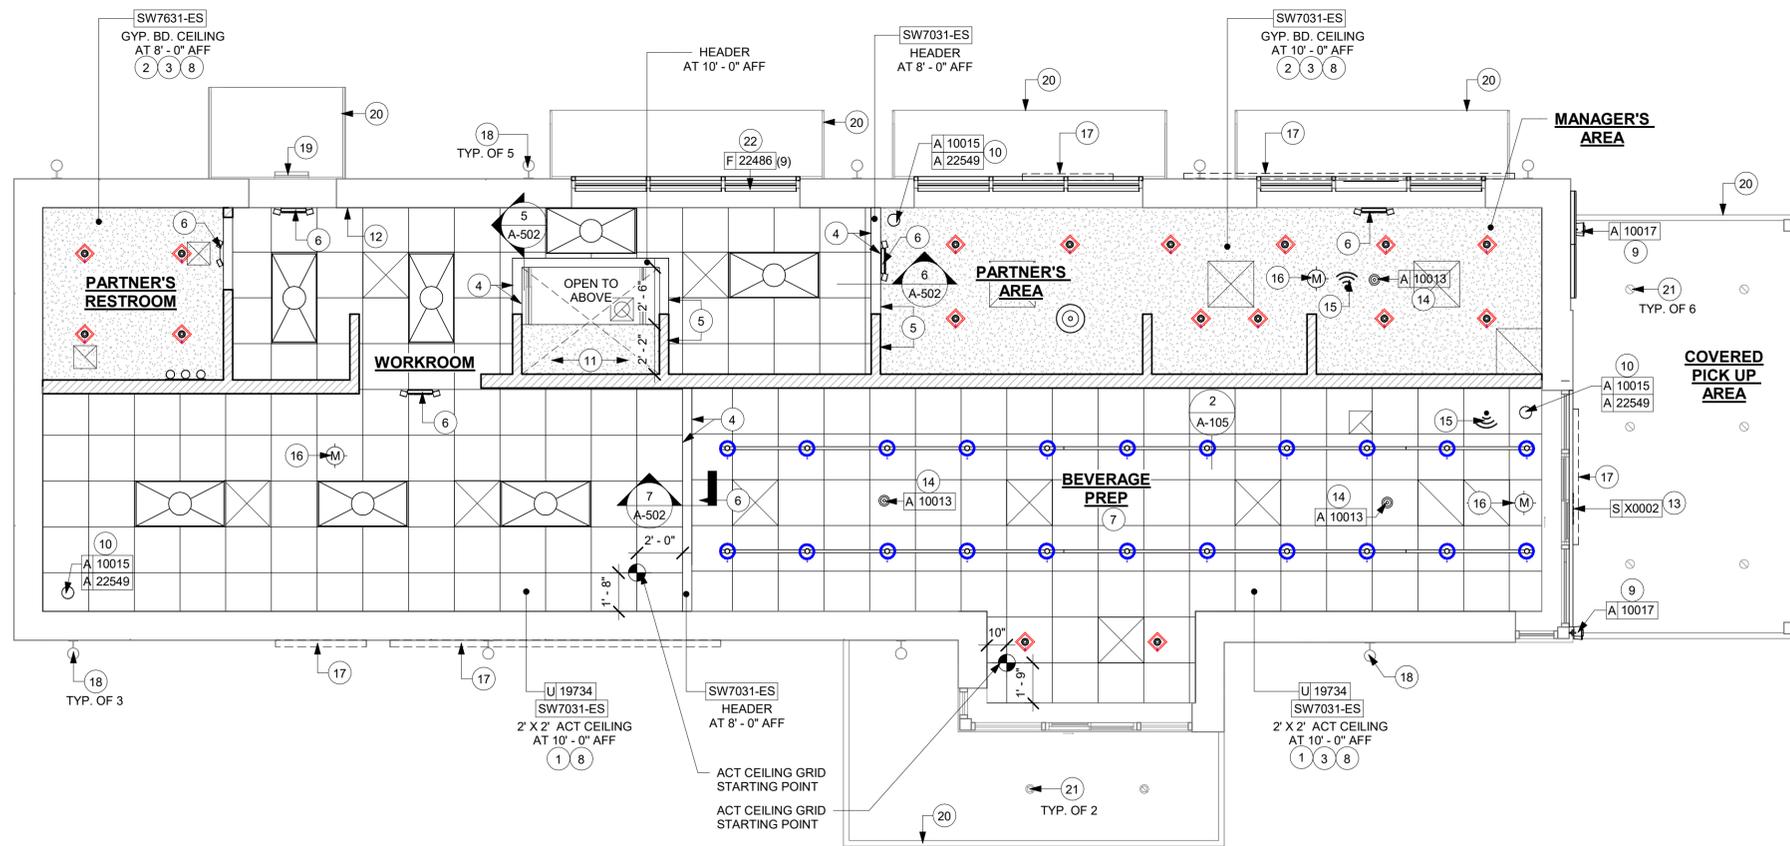

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**FOR CONSTRUCTION**

PROJECT NAME:  
**US 17-92 & LAKE MARY BLVD**

PROJECT ADDRESS:  
**3764 ORLANDO DRIVE  
 SANFORD, FL 23773**

STORE #: 81065  
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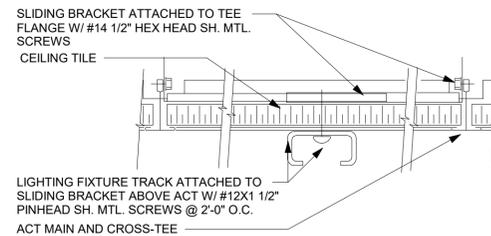
Revision Schedule			
Rev	Date	By	Description
1	09/27/23		Revision 1

SHEET TITLE:  
**REFLECTED CEILING PLAN**  
 SCALE: 1/4" = 1'-0"

SHEET NUMBER:  
**A-104**

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LIGHTING FIXTURE SCHEDULE - "L"						
DESIGN ID	COUNT	DESCRIPTION	FURN. BY	INST. BY	BULB	COMMENTS
<b>EXIT</b>						
19044	3	LED EXIT SIGN WITH EMERGENCY LIGHT - WHITE AND RED	SB	GC	INTEGRATED LED	
19047	1	LED EXIT SIGN WITH EMERGENCY LIGHT - BLACK AND GREEN	SB	GC	INTEGRATED LED	
19056	1	LED EMERGENCY LIGHT DOUBLE - WHITE	SB	GC	INTEGRATED LED	
<b>PENDANT</b>						
21422	1	PENDANT - REJUVENATION ABIGAIL SOFT CONE - UNGLAZED TOAST	SB	GC	6 W LED, AS PACKAGED	
<b>RECESSED CAN</b>						
X7001	17	CAN - CUSTOM RECESSED - BLACK - 1155LM FLOOD WITH DIMMER	SB	GC	INTEGRATED LED	
<b>SCONCE</b>						
20748	1	SCONCE - KUZCO PLUTO TRIPLE - CHROME	SB	GC	INTEGRATED LED	
<b>TRACK</b>						
12948	4	TRACK - WITH CONNECTORS - 16FT 488CM - BLACK - 1 CIRCUIT	SB	GC		ALL BAR / CAFE TRACK LIGHTING TO BE RUN THROUGH 1A / 2A CURRENT LIMITING DEVICE #RCLF12BL-TCL2BL; SEE ELECTRICAL DRAWINGS FOR ADDITIONAL INFORMATION
15058	2	TRACK - WITH CONNECTORS - 6FT 183CM - BLACK - 1 CIRCUIT	SB	GC		ALL BAR / CAFE TRACK LIGHTING TO BE RUN THROUGH 1A / 2A CURRENT LIMITING DEVICE #RCLF12BL-TCL2BL; SEE ELECTRICAL DRAWINGS FOR ADDITIONAL INFORMATION
21779	22	TRACK - LED FIXTURE WITH SNOOT - 3IN 75MM - BLACK - 1100LM FLOOD	SB	GC	INTEGRATED LED	
<b>TROFFER</b>						
21783	7	TROFFER - LED RECESSED - 24X48IN 600X1200MM - WHITE - 4300LM	SB	GC	INTEGRATED LED	



2 TRACK LIGHT - ACT MOUNT

Scale: 6" = 1'-0"

**LEGEND**

- ELEVATION DATUM
- TRACK LIGHTING
- PENDANT LIGHT
- RECESSED CAN LIGHT
- TROFFER
- WALL SCONCE
- EXIT SECURITY LIGHT
- MUSIC SYSTEM SPEAKER
- RECESSED SPEAKER
- WIFI ACCESS POINT (WAP)
- SECURITY CAMERA
- PIR MOTION SENSOR
- RR SCONCE

**LIGHTING LEGEND**

- CAN - CUSTOM RECESSED - BLACK - 1155LM WIDE FLOOD WITH DIMMER [L X7001]
- TRACK - LED FIXTURE WITH SNOOT - 3IN 75MM - BLACK - 1100LM FLOOD [L 21779]

REVIEWED FOR CODE COMPLIANCE  
 Wayne Thorne - PX3005 11-09-23  
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Timothy L. Raberding, PE  
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FOR CONSTRUCTION



PROJECT NAME:  
**US 17-92 & LAKE MARY BLVD**


PROJECT ADDRESS:  
**3764 ORLANDO DRIVE  
 SANFORD, FL 23773**

STORE #: 81065  
 PROJECT #: 98504-001  
 ISSUE DATE: 08-03-2023  
 DESIGNER: PAULINA LOPEZ  
 PRODUCTION DESIGNER: ANDY MCLLOUD  
 CHECKED BY: DONALD RETHMAN

Revision Schedule			
Rev	Date	By	Description


SHEET TITLE:  
**DIMENSIONED CEILING AND LIGHTING PLAN**  
 SCALE: AS SHOWN

SHEET NUMBER:  
**A-105**

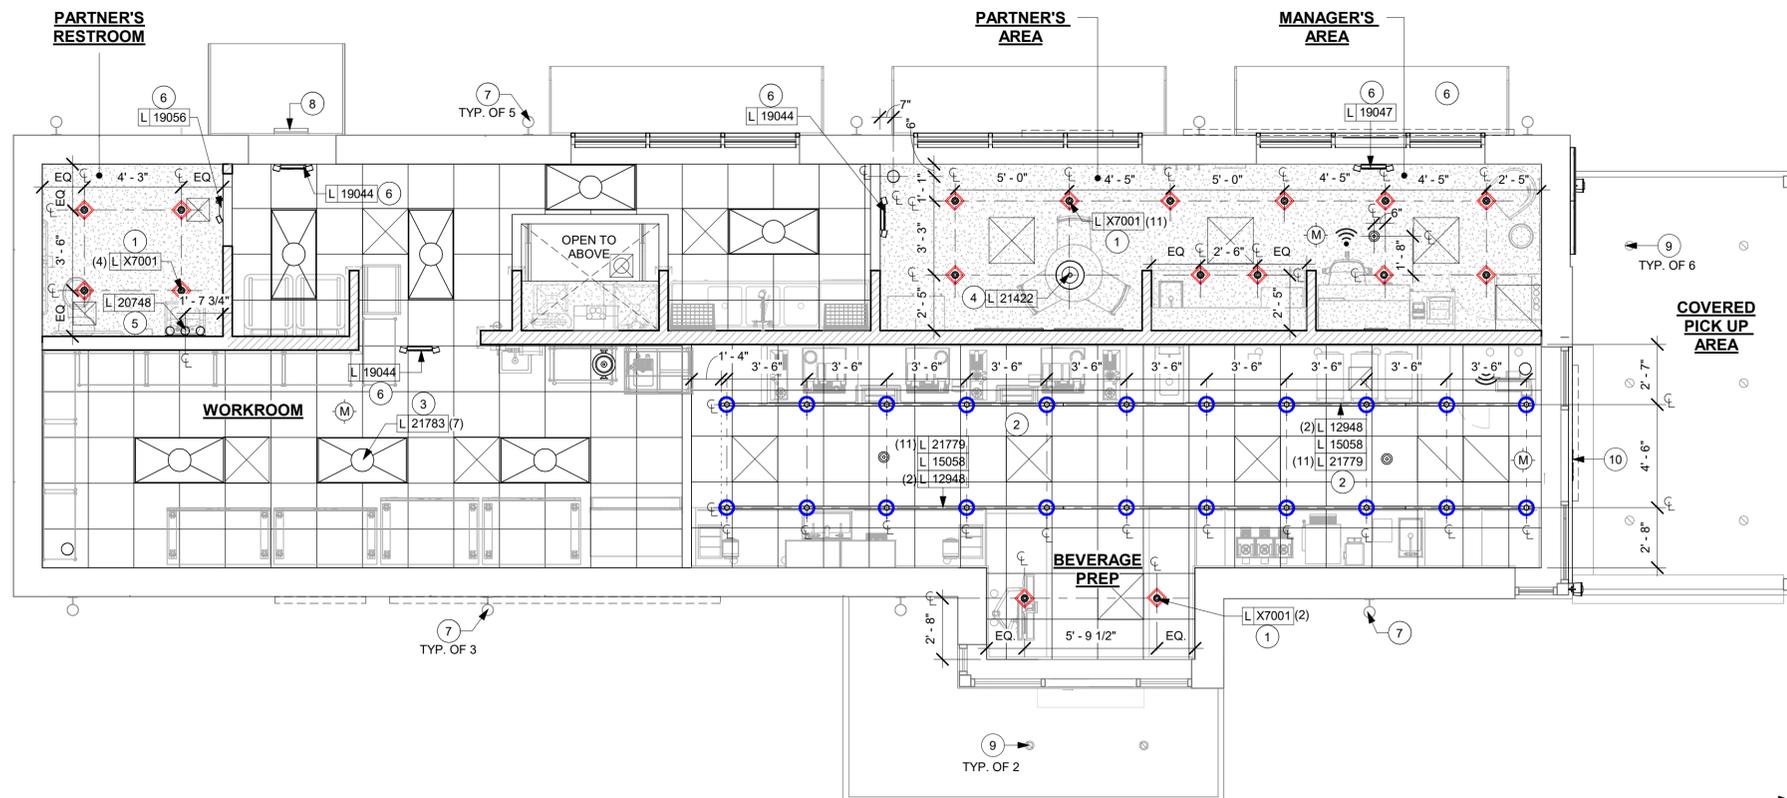

1 DIMENSIONED CEILING AND LIGHTING PLAN

Scale: 1/4" = 1'-0"

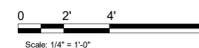

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**FOR CONSTRUCTION**

PROJECT NAME:  
**US 17-92 & LAKE MARY BLVD**

PROJECT ADDRESS:  
**3764 ORLANDO DRIVE  
 SANFORD, FL 32773**


STORE #: 81065  
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 CHECKED BY: DONALD RETHMAN

Revision Schedule			
Rev	Date	By	Description


SHEET TITLE:  
**BUILDING DETAILS**

SCALE: AS SHOWN


SHEET NUMBER:  
**A-501**

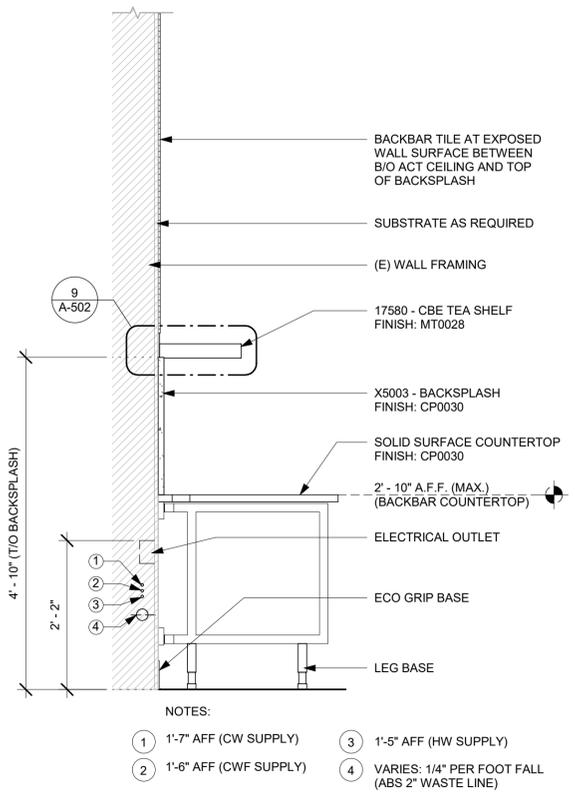


**1 WALL SECTION AT BACKBAR**  
 Scale: 3/4" = 1'-0"

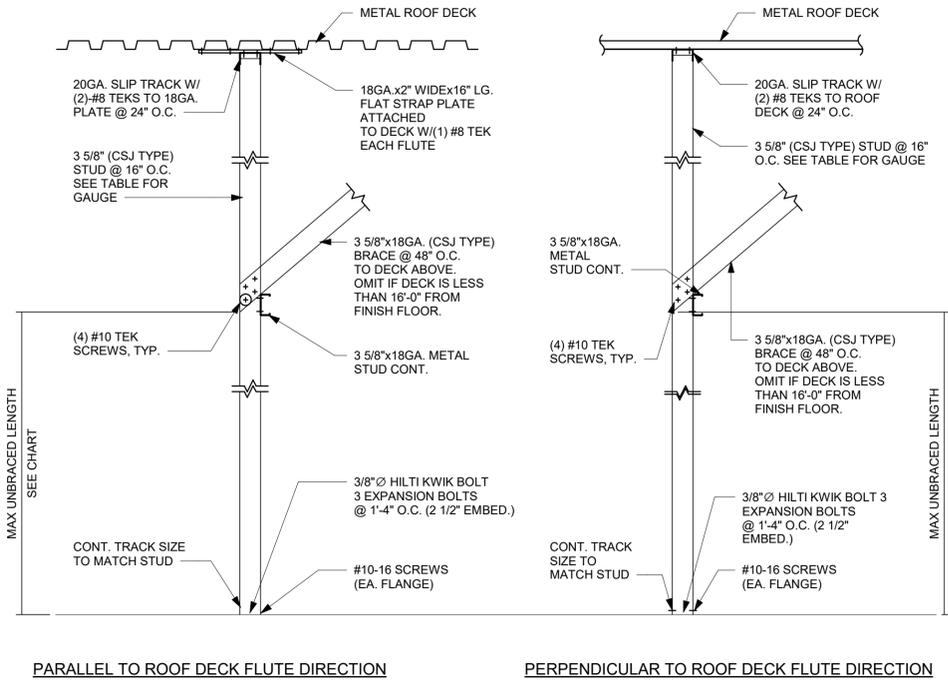


**2 NEW PARTITION WALL TO STRUCTURE**  
 Scale: 3/4" = 1'-0"

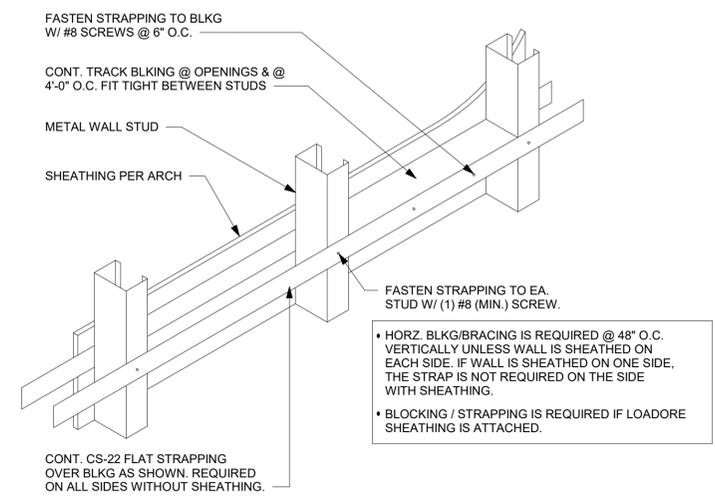

**3 TYPICAL WALL BLOCKING\_BRACING**  
 Scale: 3/4" = 1'-0"

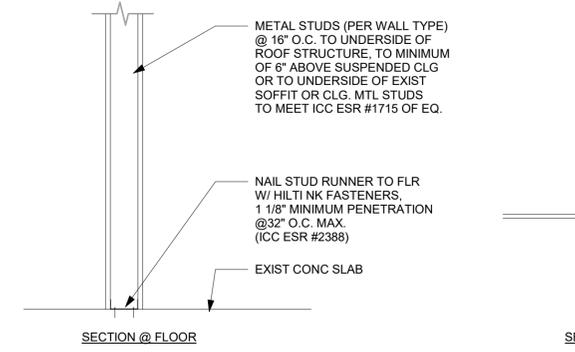


**4 NEW PARTITION WALL 6" ABOVE CEILING**  
 Scale: 1" = 1'-0"

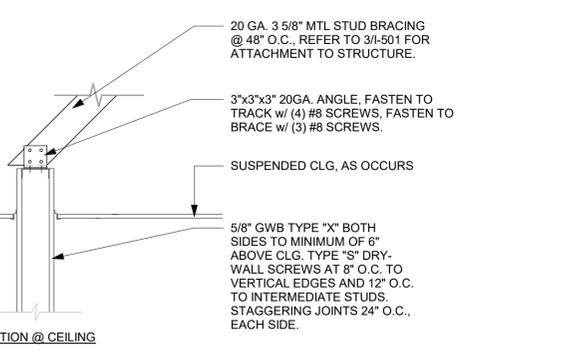

PARTITION WALL SCHEDULE					
WALL HEIGHT	STUD SIZE	DEFL TRACK	DEFL TRACK SPANNING BTWN (E) JOISTS	BOT TRACK	
15 FEET	362S137-33	33 MIL	JST @ 4' O.C. JST @ 6' O.C.	54 MIL 68 MIL	33 MIL
20 FEET	550S162-33	33 MIL	JST @ 4' O.C. JST @ 6' O.C.	68 MIL 97 MIL	33 MIL
25 FEET	600S200-43	43 MIL	JST @ 4' O.C. JST @ 6' O.C.	68 MIL 97 MIL	33 MIL

**5 PARTITION WALL SCHEDULE**  
 Scale: 3/4" = 1'-0"

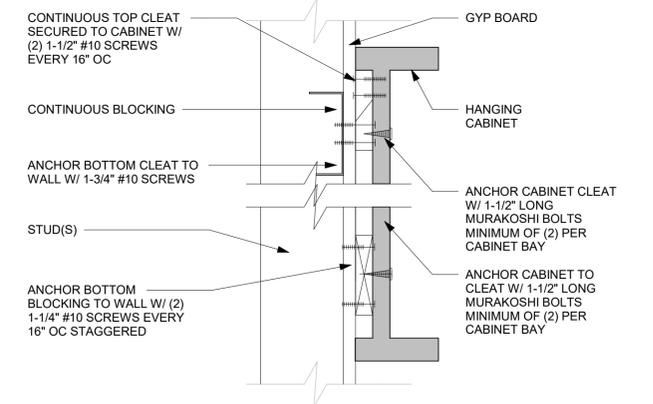


**6 ANCHOR DETAIL**  
 Scale: 3" = 1'-0"

WALL TYPE FASTENER SCHEDULE			
WALL TYPE	WALL BLOCKING	FASTENERS	NOTES
WOOD FRAME	X	#8 X3" (75MM) W/D OR EQUIVALENT	REFER TO BLOCKING REQUIREMENTS
METAL FRAME	X	#6CT. X1 1/4" (30MM) MTL W/D OR EQUIVALENT	REFER TO BLOCKING REQUIREMENTS
CMU		MIN. 5/16"x3" (20MMx75MM) TARPON OR EQUIVALENT	SPACE PER DETAIL THIS SHEET
CONCRETE		MIN. 1/4"x3" (7MMx75MM) SLEEVE ANCHOR OR EQUIVALENT	SPACE PER DETAIL THIS SHEET
BRICK		MIN. 1/4"x1" (7MMx25MM) WEDGE ANCHOR OR EQUIVALENT	SPACE PER DETAIL THIS SHEET AVOID SETTING ANCHORS IN MORTAR JOINTS

**STUD WALL BLOCKING REQUIREMENTS:**  
 WOOD STUD WALLS REQUIRE MIN. 2"x6" (50MMx150MM) WOOD BLOCKING SECURED FLUSH TO STUD FACE WITH (3) 10D NAILS (OR EQUIVALENT)

METAL STUD WALLS REQUIRE MIN. 2"x6" (50MMx150MM) WOOD BLOCKING SECURED FLUSH TO STUD FACE WITH MIN. (3) #6 CT. 1.25" (30MM) SCREWS (OR EQUIVALENT)

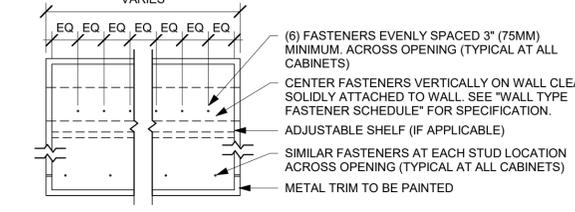

**7 UPPER CABINET ATTACHMENT**  
 Scale: 1" = 1'-0"



C:\Users\kailey.jennings\Documents\98504-001\_81065\_US 17-92 & Lake Mary Blvd., FL\_2021\_kailey.jennings.rvt 11/6/2023 1:16:58 PM

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 Timothy L. Raberding, PE  
 Professional Engineer  
 License: 62078



**FOR CONSTRUCTION**

PROJECT NAME:  
**US 17-92 & LAKE MARY BLVD**  
 PROJECT ADDRESS:  
**3764 ORLANDO DRIVE  
 SANFORD, FL 32773**


STORE #: 81065  
 PROJECT #: 98504-001  
 ISSUE DATE: 08-03-2023  
 DESIGNER: PAULINA LOPEZ  
 PRODUCTION DESIGNER: ANDY MCLLOUD  
 CHECKED BY: DONALD RETHMAN

Revision Schedule			
Rev	Date	By	Description


SHEET TITLE:  
**BUILDING DETAILS**

SCALE: AS SHOWN


SHEET NUMBER:  
**A-502**

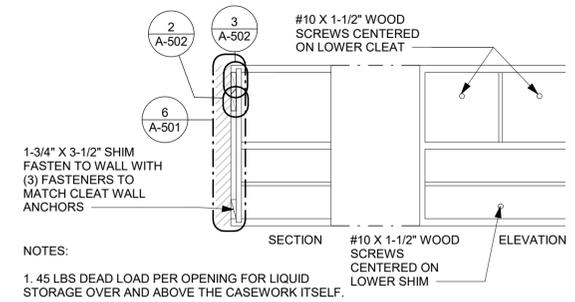


**1 BLOCKING AT CASEWORK**  
 Scale: 1/2" = 1'-0"

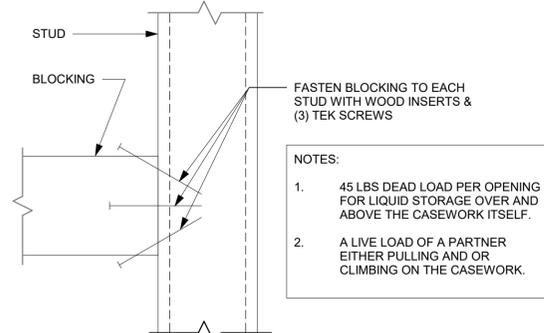


**2 BLOCKING TO METAL STUD**  
 Scale: 1/2" = 1'-0"

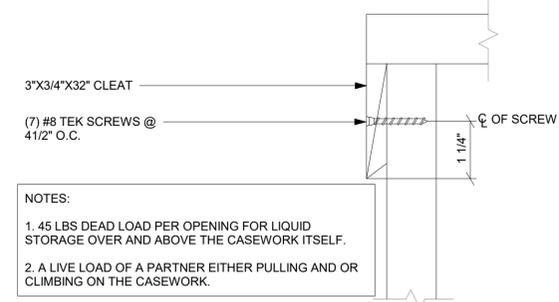


**3 CLEAT TO FRAME**  
 Scale: 1/2" = 1'-0"

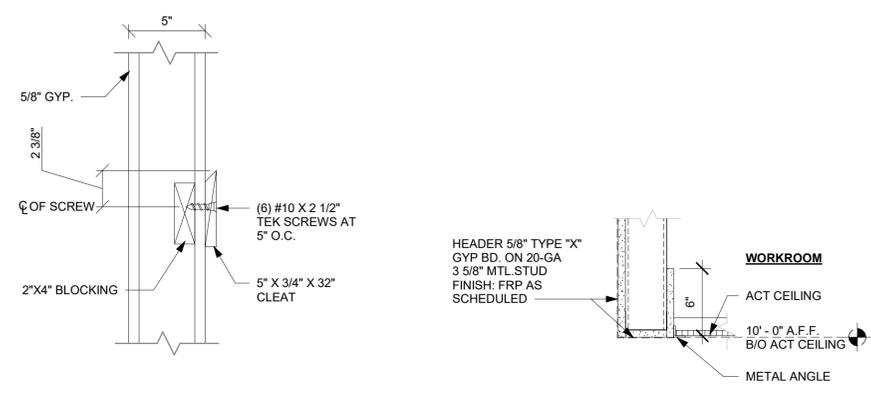


**4 CLEAT TO WOOD BLOCKING**  
 Scale: 1/2" = 1'-0"

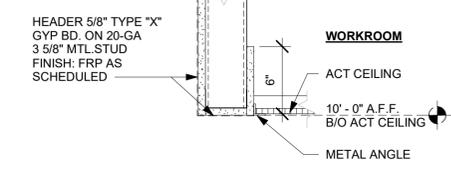


**5 HEADER AT WATER FILTERATION**  
 Scale: 1 1/2" = 1'-0"

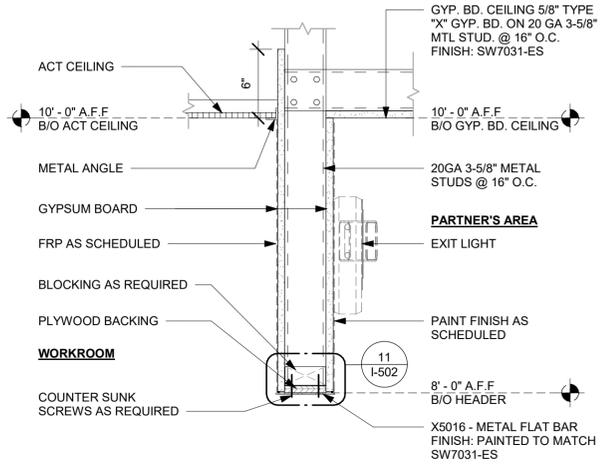

**6 HEADER AT PARTNER AREA**  
 Scale: 1 1/2" = 1'-0"

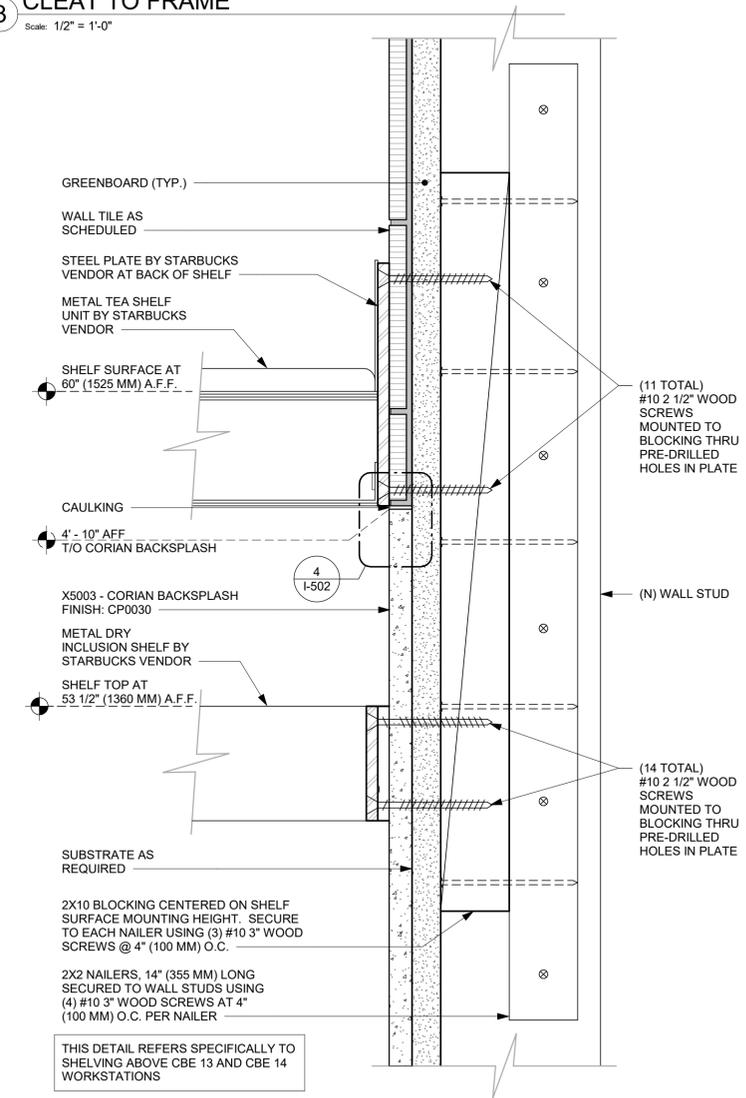


**9 METAL TEA AND DRY INCLUSION SHELF ATTACHMENT**  
 Scale: 6" = 1'-0"

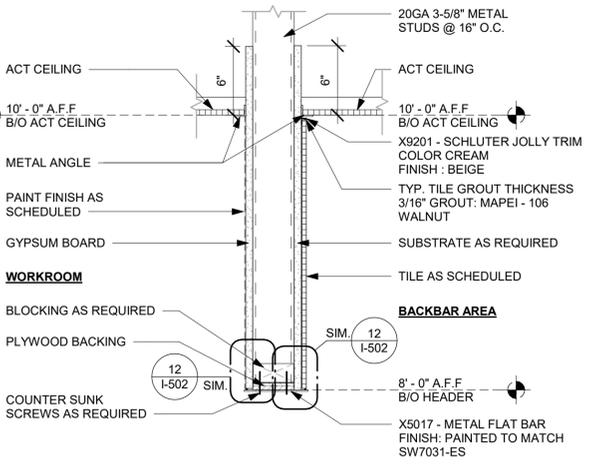


**7 HEADER AT ENGINE AREA**  
 Scale: 1 1/2" = 1'-0"

NOTE:  
GC TO PROVIDE PLUMBING AND ELECTRICAL CONNECTIONS. VENDOR TO INSTALL SYSTEM.

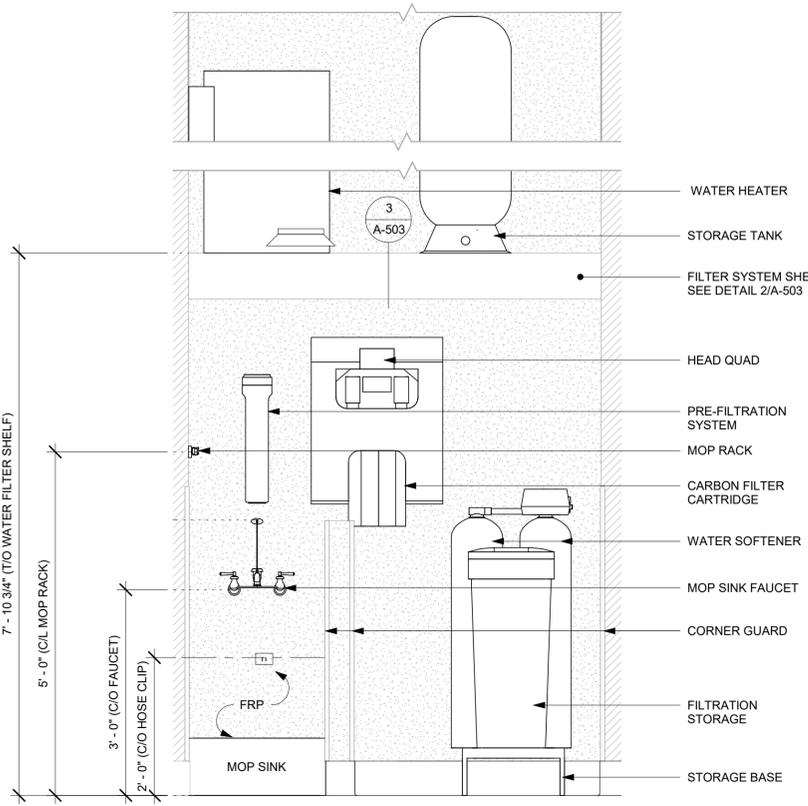


1 WATER SYSTEM - ELEVATION  
Scale: 3/4" = 1'-0"

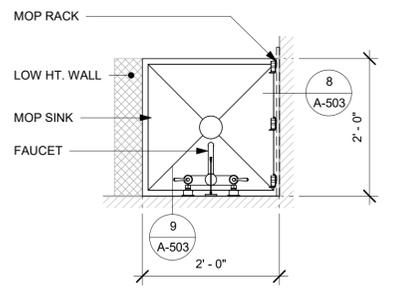


7 MOP SINK - PLAN  
Scale: 3/4" = 1'-0"


9 FRP AT MOP SINK  
Scale: 1 1/2" = 1'-0"

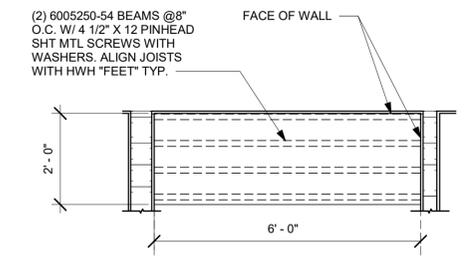


2 FILTER SYSTEM SHELF PLAN  
Scale: 1/2" = 1'-0"

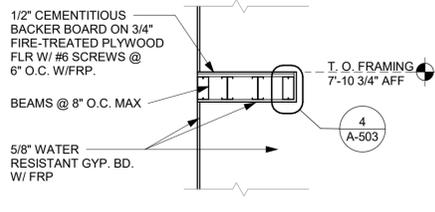

3 FILTER SYSTEM SHELF SECTION  
Scale: 1/2" = 1'-0"

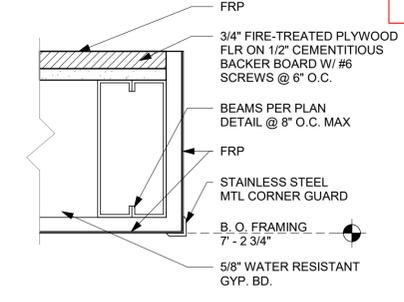


4 FILTER SYSTEM SHELF EDGE  
Scale: 3" = 1'-0"

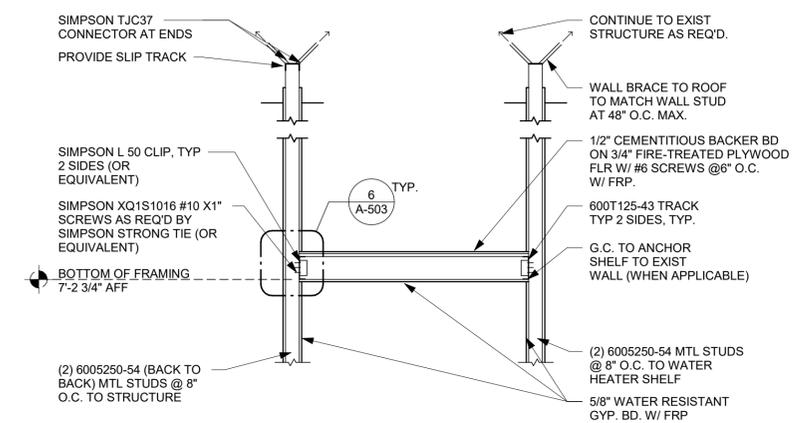


5 FILTER SYSTEM SHELF ELEVATION1  
Scale: 1/2" = 1'-0"

NOTES TO CONTRACTOR:  
1. PRE DRILL HOLES THROUGH S.S. ANGLE TO PREVENT DAMAGE TO SCREWS.  
2. TEK SCREWS OR EQUIVALENT TO BE USED.  
3. ANGLE TO BE CONTINUOUS (NO SPLICES)

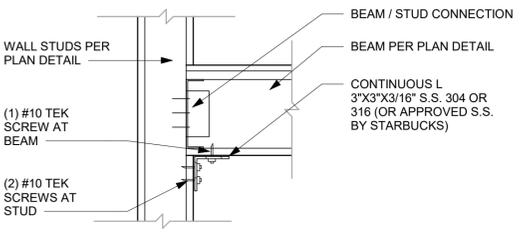


6 FILTER SYSTEM SHELF ANGLE SUPPORT DETAIL  
Scale: 1 1/2" = 1'-0"

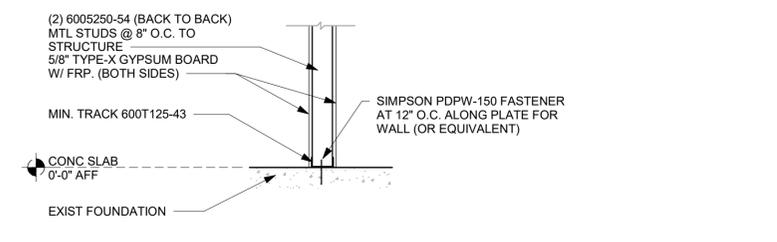


8 FILTER SYSTEM SHELF CONNECTION AT FOUNDATION  
Scale: 3/4" = 1'-0"

-SECURE TUBING TO WALL ABOVE SINK BACKSPASH W/ ZIP TIES.  
-MOUNT TEST STRIP BOX TO WALL OVER THE "CLEAN" DRAINBOARD.  
-ARCHITECT TO COORDINATE WITH LICENSEE REGARDING SAN/WASH EQUIPMENT.  
-MOUNT SAN/WASH EQUIPMENT TO WALL ABOVE THE "DIRTY" SIDE OF THE SINK ONLY.

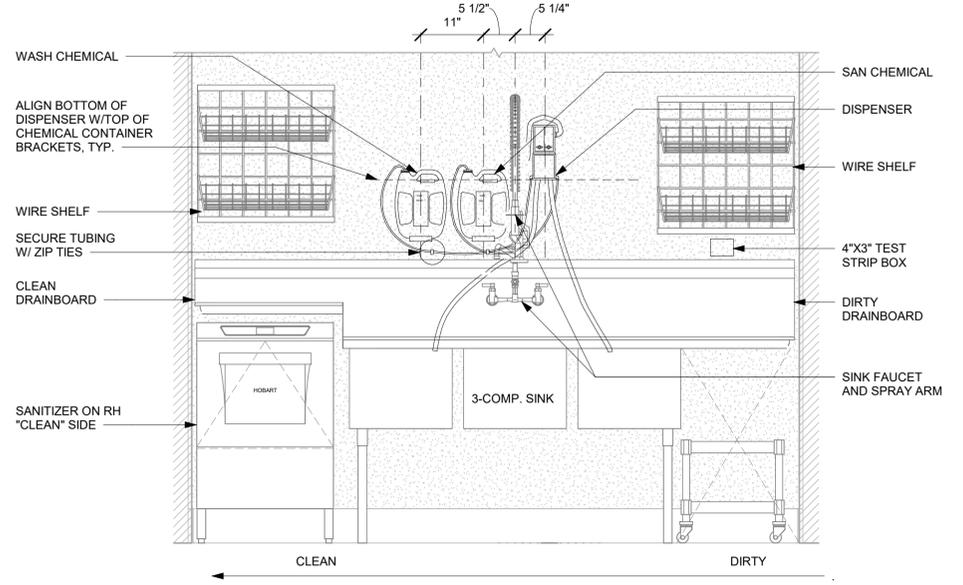

11 CLICK SAN/WASH INSTALL (SANITIZER BELOW)  
Scale: 3/4" = 1'-0"

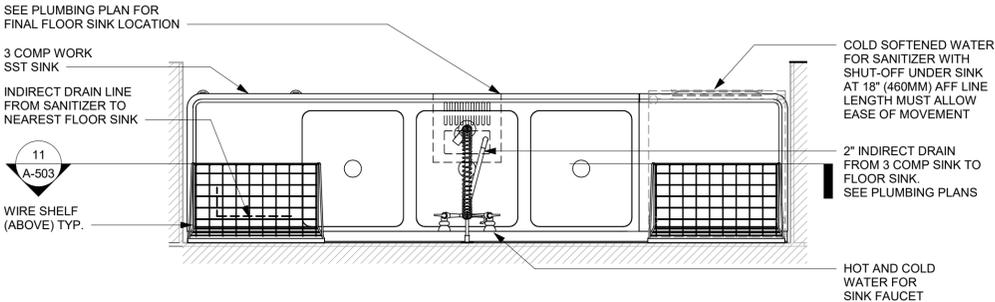

10 3 - COMP PLAN - SANITIZER(UNDER)  
Scale: 3/4" = 1'-0"

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11/06/2023

FOR CONSTRUCTION

PROJECT NAME:  
**US 17-92 & LAKE MARY BLVD**

PROJECT ADDRESS:  
**3764 ORLANDO DRIVE  
SANFORD, FL 23773**

STORE #: 81065  
PROJECT #: 98504-001  
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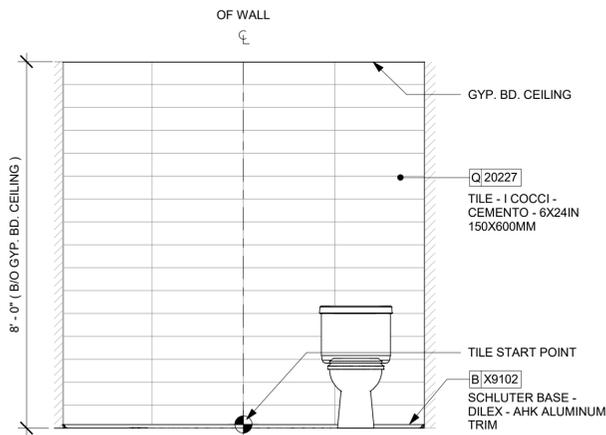
Revision Schedule			
Rev	Date	By	Description

SHEET TITLE:  
**WORKROOM DETAILS**

SCALE: AS SHOWN


SHEET NUMBER:  
**A-503**

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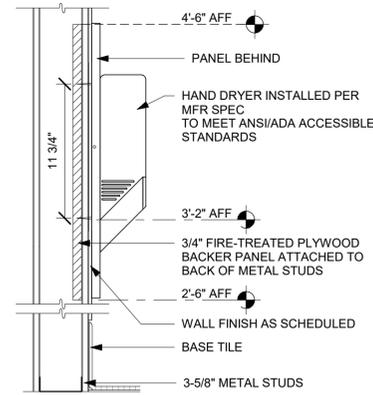
1 WALL TILE PATTERN AT RESTROOM

Scale: 1/2" = 1'-0"





2 HAND DRYER SECTION

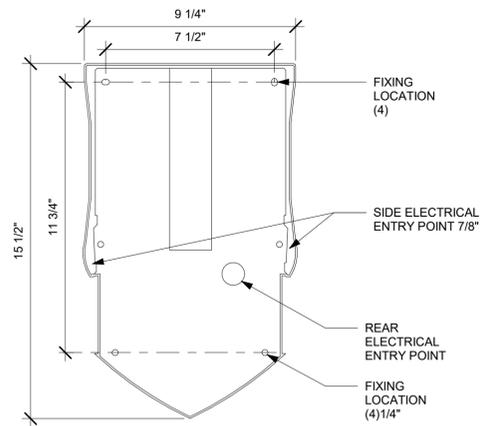Scale: 3" = 1'-0"




3 HAND DRYER BLOCKING

Scale: 1 1/2" = 1'-0"

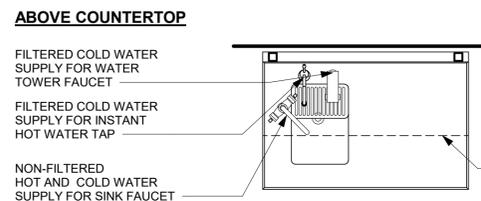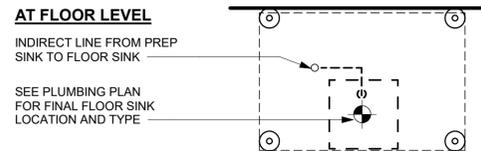


5 WATER FILLING STATION - PLUMBING

Scale: 3/4" = 1'-0"

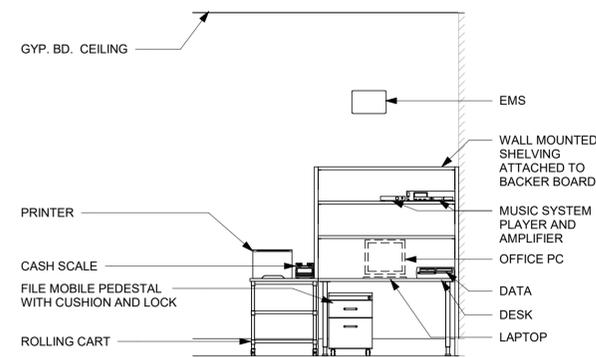

6 MANAGER'S DESK (DETAIL FOR INSTALLATION)

Scale: 3/8" = 1'-0"

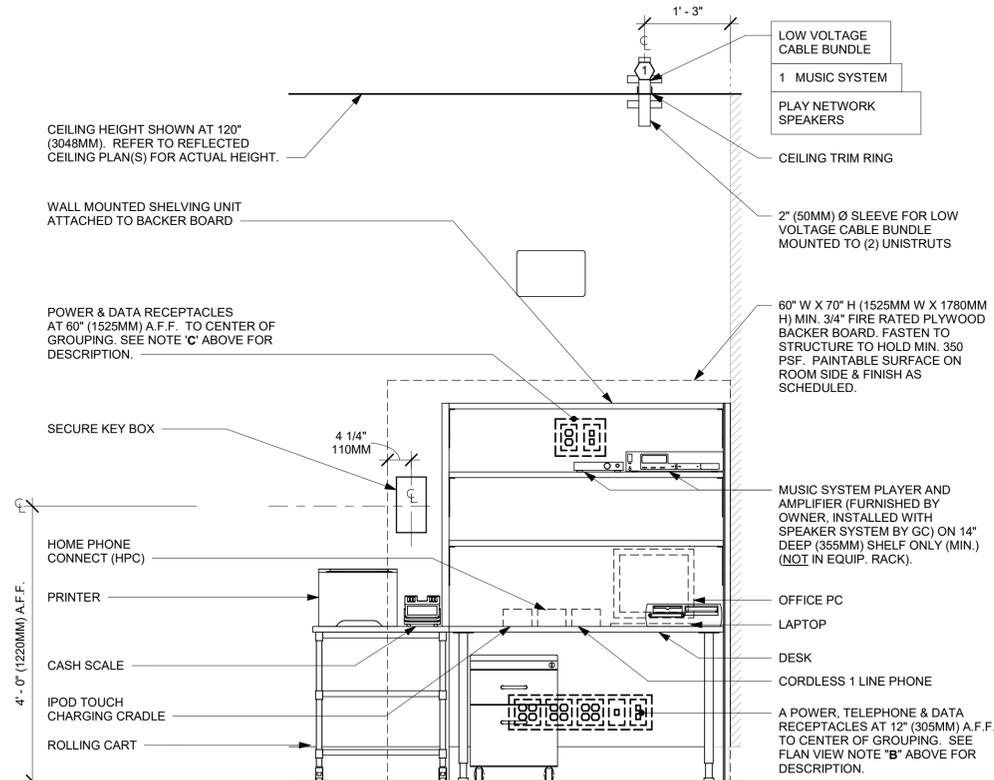


ELEVATION VIEW

NOTE: EQUIPMENT SHOWN AS DASHED LINES IS TO BE FURNISHED AND INSTALLED BY OWNER UNLESS NOTED OTHERWISE.

7 MANAGER'S WORKROOM - ELECTRICAL

Scale: 3/4" = 1'-0"

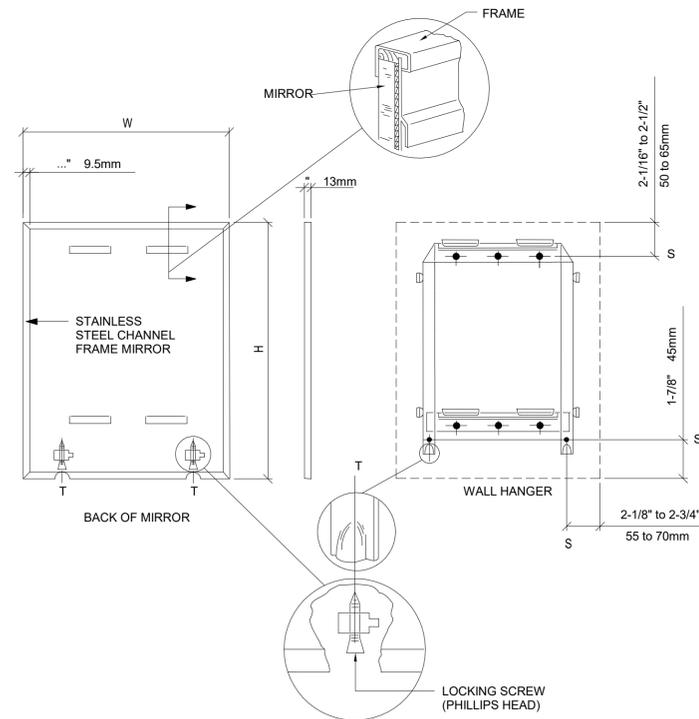

4 MIRROR MOUNTING

Scale: 3/4" = 1'-0"

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STARBUCKS TEMPLATE VERSION: 12021-09-13

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FOR CONSTRUCTION

PROJECT NAME:  
**US 17-92 & LAKE MARY BLVD**

PROJECT ADDRESS:  
**3764 ORLANDO DRIVE  
 SANFORD, FL 23773**


STORE #: 81065  
 PROJECT #: 98504-001  
 ISSUE DATE: 08-03-2023  
 DESIGNER: PAULINA LOPEZ  
 PRODUCTION DESIGNER: ANDY MCLLOUD  
 CHECKED BY: DONALD RETHMAN

Revision Schedule			
Rev	Date	By	Description

SHEET TITLE:  
**RESTROOM AND WORKROOM DETAILS**  
 SCALE: AS SHOWN

SHEET NUMBER:  
**A-504**

**DOOR LEGEND**

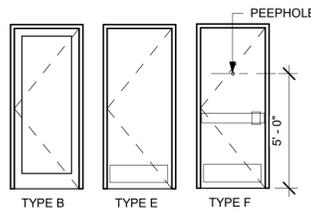

**STOREFRONT DOOR (TYPE B)**

DOOR HARDWARE SET NO. 2 - For new single aluminum main entry/exit door				
No.	Item	Description	Manufacturer	Finish
3	Hanging Devices	TH2314/MPB91	McKinney	630
1	Securing Devices	MS1851S Deadbolt	Adams Rite	628
1	Sign	Vinyl Sign: "THIS DOOR MUST REMAIN UNLOCKED WHEN BUILDING IS OCCUPIED"	Seton	---
2	Securing Devices	C607 7-Pin Core Combined "A" Keyway	Falcon Lock	626
1	Securing Devices	KB609-2 Cut Control Key "A" Keyway	Falcon Lock	---
9	Securing Devices	KB632-2 Cut User Key "A" Keyway	Falcon Lock	---
2	Securing Devices	C987 7-Pin Mortise Cylinder Housing w/AR Cam 26D	Falcon Lock	626
2	Securing Devices	A08794-003 Adjustable Ring, Mortise Cyl. 5/16-13/32	Falcon Lock	626
1	Operating Trim	108 Door Pull Handle 32D	Rockwood	630
1	Operating Trim	48 Push Bar x 31	Rockwood	630
1	Closing Devices	8916 Door Closer 8916 AF89P	Dorma	689
1	Stops and Holders	473 Door Stop w/Hook	Rockwood	626
1	Threshold	325 Half Saddle Threshold	National Guard	---

**RESTROOM DOOR (TYPE E)**

DOOR HARDWARE SET NO. 6 - For restroom door with lever and privacy lock				
No.	Item	Description	Manufacturer	Finish
3	Hanging Items	TA2714/MPB79 Hinge MacPro Bearing 4.5 x 4.5	McKinney	626
1	Securing Devices	PB5425LN Lock, Shallow Coin Turn, Privacy PB5425LN-693-497 1-3/4	Yale Lock	626
1	Closing Devices	8916 Door Closer 8916 AF89P	Dorma	689
2	Protective Trim Units	K1050 B4E Kickplate 8" x 34" Each Side 32D	Rockwood	630
3	Accessories	GJ64 Rubber Silencer	Glynn Johnson	Gray
1	Stops and Holders	473 Door Stop w/ Hook	Rockwood	626

**SERVICE DOOR (TYPE F)**

DOOR HARDWARE SET NO. 42 - For exterior 42" wide service door				
No.	Item	Description	Manufacturer	Finish
3	Hanging Devices	TH2314/MPB91 Hinge MacPro Bearing 4.5 x 4.5	McKinney	630
1	Securing Devices	C607 7-Pin Core Combined "A" Keyway	Falcon Lock	626
1	Securing Devices	I/O 2000L-031C Auto Locking Door Alarm, IC; No CTR Includes Mortise Cylinder	Sur-Lock	---
1	Closing Devices	8916 Door Closer 8916 AF89P	Dorma	689
1	Protective Trim Units	K1050 B4E Kickplate 10" x 40"	Rockwood	630
1	Accessories	137NA Weather Strip 20" 42" x 84"	National Guard	A
1	Accessories	Door Sweep 18062CNB36	Pemko	A
1	Miscellaneous Items	DS / 1000 Door Scope	Security Products	Silver
1	Miscellaneous Items	MCV309NWHGL Door Bell	Nutone	As Selected

DOOR SCHEDULE - "D"					
DESIGN ID	COUNT	DESCRIPTION	FURN. BY	INST. BY	COMMENTS
DOOR					
10190	1	DOOR - SINGLE FLUSH - 36IN - TYPE E	SB	GC	DOOR FINISH: WD0035 (STAIN TO MATCH); FRAME FINISH: SW6991-SG; LOCKNET; SEE HARDWARE SET #6; DOOR TYPE E
X2001	1	DOOR - STOREFRONT METAL FRAME SINGLE - TYPE B	EXIST	EXIST	DOOR; LOCKNET; DOOR FINISH: DID19458 DUSTED CRYSTAL; FRAME FINISH: BLACK ANODIZED ALUMINIUM; SEE HARDWARE SET # 2
X2002	1	DOOR - SINGLE FLUSH - SERVICE DOOR - 42IN - TYPE F	EXIST	EXIST	DOOR FINISH: SW7033-SG; LOCKNET; SEE HARDWARE SET #42; DOOR TYPE F;

STOREFRONT SCHEDULE - "W"					
DESIGN ID	COUNT	DESCRIPTION	FURN. BY	INST. BY	COMMENTS
WINDOW					
10118	2	WINDOW - DT HURRICANE RATED - 48X44IN 1205X1105MM - ALUMINUM	EXIST	EXIST	LL TO SPECIFY IMPACT GLASS OR NON-IMPACT GLASS AS REQUIRED. CONTACT DAN RADEK AT dan@ready-access.com 1-800-621-5045

**RESPONSIBILITY LEGEND**

FURN. BY	INST. BY
SB - FURNISHED BY STARBUCKS	GC - INSTALLED BY GENERAL CONTRACTOR
GC - FURNISHED BY GENERAL CONTRACTOR	SB - INSTALLED BY STARBUCKS
VD - FURNISHED BY VENDOR	VD - INSTALLED BY VENDOR

**NOTE:** ALL RESPONSIBILITIES TO BE CONFIRMED WITH STARBUCKS CONSTRUCTION MANAGER PRIOR TO ORDERING / CONSTRUCTION.

**REVIEWED FOR CODE COMPLIANCE**  
 Wayne Thorne - PX3005 11-09-23  
 A PERMIT ISSUED SHALL BE CONSTRUED TO BE A LICENSE TO PROCEED WITH THE WORK AND NOT AS AUTHORITY TO VIOLATE, CANCEL, ALTER OR SET ASIDE ANY OF THE PROVISIONS OF THE TECHNICAL CODES, NOR SHALL ISSUANCE OF A PERMIT PREVENT THE BUILDING OFFICIAL FROM THEREAFTER REQUIRING A CORRECTION OF ERRORS IN PLANS, CONSTRUCTION OR VIOLATIONS OF THIS CODE.



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**FOR CONSTRUCTION**

PROJECT NAME:  
**US 17-92 & LAKE MARY BLVD**  
 PROJECT ADDRESS:  
**3764 ORLANDO DRIVE  
 SANFORD, FL 32773**

STORE #: 81065  
 PROJECT #: 98504-001  
 ISSUE DATE: 08-03-2023  
 DESIGNER: PAULINA LOPEZ  
 PRODUCTION DESIGNER: ANDY MCLLOUD  
 CHECKED BY: DONALD RETHMAN

Revision Schedule			
Rev	Date	By	Description

SHEET TITLE:  
**WINDOW AND DOOR SCHEDULES**  
 SCALE: NO SCALE

SHEET NUMBER:  
**A-601**

1/16/2023 1:19:35 PM C:\Users\kallej.jennings\Documents\98504-001\_81065\_US 17-92 & Lake Mary Blvd, FL\_2021\_kalley.jennings.rvt

REVIEWED FOR CODE COMPLIANCE  
Wagne Thorne - PX3005 11-09-23  
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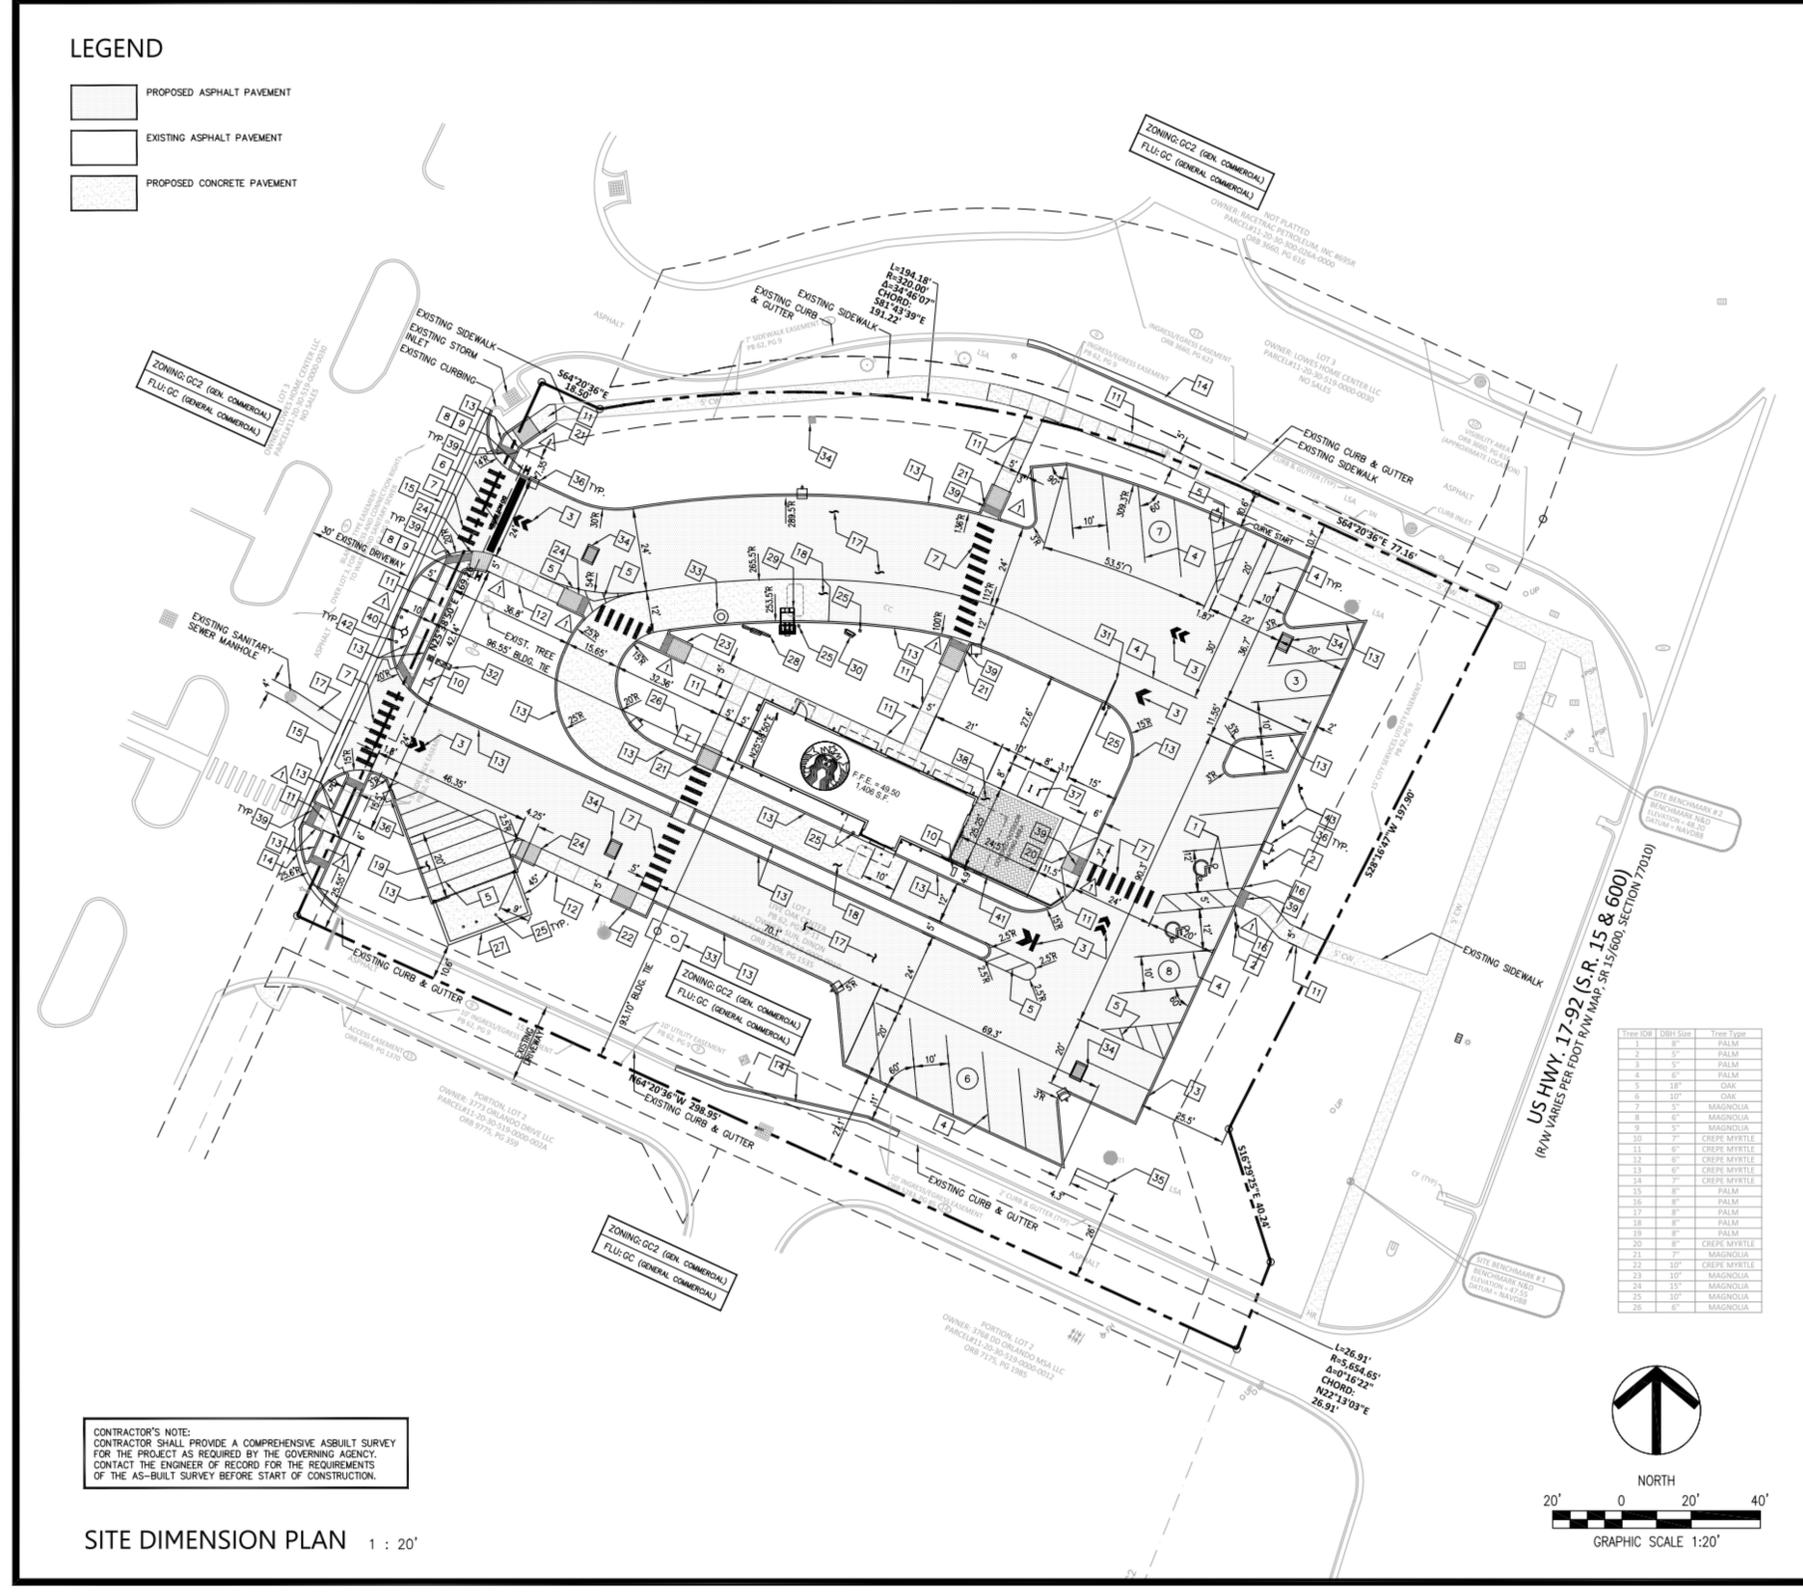
Revision Schedule

Rev	Date	By	Description

SHEET TITLE:  
**LL SITE PLAN**

SCALE: 1" = 20'-0"

SHEET NUMBER:  
**SP001**



- ### PLAN NOTES
- 1 ACCESSIBLE PARKING, STRIPING AND ACCESS AISLE (1/CE)
  - 2 ACCESSIBLE PARKING SIGN (2/CE)
  - 3 PAVEMENT MARKING (3/CE)
  - 4 4" WHITE STRIPING (PAINT)
  - 5 4" DIAGONAL WHITE STRIPING AT 4.5 FT. O.C. (PAINT)
  - 6 24" WHITE STOP BAR (PAINT) (3/CE)
  - 7 CROSSWALK (PAINT) (3/CE)
  - 8 24" STOP SIGN (MUTCD R1-1)
  - 9 "DO NOT ENTER" SIGN (MUTCD R5-1)
  - 10 DIRECTIONAL SIGN (SEE SIGNAGE PLANS)
  - 11 CONCRETE WALK WITH EXPANSION JOINTS & SCORE MARKS (4/CE)
  - 12 MONOLITHIC CURB AND SIDEWALK (5/CE)
  - 13 6" VERTICAL CURB (6/CE)
  - 14 CURB AND GUTTER (7/CE)
  - 15 VALLEY GUTTER (8/CE)
  - 16 TRANSITION CURB (9/CE)
  - 17 ASPHALT PAVEMENT (10/CE)
  - 18 7" THICK BLACK INTEGRAL CONCRETE REINFORCED WITH WELDED WIRE MESH PER STARBUCKS SPECIFICATIONS
  - 19 BLACK DUMPSTER CONCRETE APRON (12/CE)
  - 20 ACCESSIBLE RAMP (CR A - FDOT INDEX 522-002) (13/CE)
  - 21 ACCESSIBLE RAMP (CR E - FDOT INDEX 522-002) (14/CE)
  - 22 ACCESSIBLE RAMP (CR D - FDOT INDEX 522-002) (15/CE)
  - 23 ACCESSIBLE RAMP (CR F - FDOT INDEX 522-002) (16/CE)
  - 24 ACCESSIBLE RAMP (CR G - FDOT INDEX 522-002) (17/CE)
  - 25 CONCRETE BOLLARD B (2/CE.1)
  - 26 POWER TRANSFORMER AND CONCRETE PAD
  - 27 SOLID WASTE ENCLOSURE (SEE ARCHITECTURAL PLANS)
  - 28 MENU BOARD (SEE SIGNAGE PLANS)
  - 29 CANOPY AND ORDERING STATION (SEE SIGNAGE PLANS)
  - 30 PRE-SELL MENU BOARD (SEE SIGNAGE PLANS)
  - 31 CLEARANCE BAR (SEE SIGNAGE PLANS)
  - 32 BACKFLOW PREVENTER & WATER METER (SEE UTILITY PLAN)
  - 33 SANITARY SEWER STRUCTURE (SEE UTILITY PLAN)
  - 34 STORMWATER STRUCTURE (SEE GRADING & DRAINAGE PLAN)
  - 35 MONUMENT SIGN (SEE SIGNAGE PLANS)
  - 36 LIGHT POLE (SEE PHOTOMETRICS PLAN)
  - 37 BICYCLE RACKS (4 PARKING SPACES) (2/CE.1)
  - 38 BRICK PAVERS (SEE ARCHITECTURAL PLANS FOR DETAILS)
  - 39 DETECTABLE WARNING MAT (4/CE.1)
  - 40 FIRE HYDRANT ASSEMBLY WITH BOLLARDS
  - 41 PATIO RAILING (REFER TO ARCHITECTURAL PLANS)
  - 42 CONCRETE BOLLARD A (1/CE.1)
  - 43 "MOBILE ORDER PICK-UP - 10 MIN. PARKING" SIGN (SEE SIGNAGE PLANS)
- REFER TO SHEET C0 FOR GENERAL NOTES, SPECIFICATIONS AND LEGENDS IN ADDITION TO SITE SPECIFIC NOTES AND REQUIREMENTS.

Tree ID#	DBH1 Stem	Tree Type
1	8"	PALM
2	3"	PALM
3	3"	PALM
4	6"	PALM
5	18"	DAK
6	30"	DAK
7	3"	MAGNOLIA
8	3"	MAGNOLIA
9	3"	MAGNOLIA
10	7"	CREPE MYRTLE
11	8"	CREPE MYRTLE
12	8"	CREPE MYRTLE
13	8"	CREPE MYRTLE
14	8"	CREPE MYRTLE
15	8"	PALM
16	8"	PALM
17	8"	PALM
18	8"	PALM
19	8"	PALM
20	8"	CREPE MYRTLE
21	7"	MAGNOLIA
22	30"	CREPE MYRTLE
23	10"	MAGNOLIA
24	15"	MAGNOLIA
25	30"	MAGNOLIA
26	8"	MAGNOLIA

**Z DEVELOPMENT**  
S e r v i c e s  
CA 29354  
708 E. COLONIAL DR., STE. 100  
ORLANDO, FL 32803  
PH: (407) 271-8910  
FAX: (407) 442-0604

DATE: 11-21-22  
DRAWN: SR  
CHECKED: BZ

**C2**  
SITE DIMENSION PLAN

PROJECT NO.: 2022.171

CONTRACTOR'S NOTE:  
CONTRACTOR SHALL PROVIDE A COMPREHENSIVE ASBUILT SURVEY FOR THE PROJECT AS REQUIRED BY THE GOVERNING AGENCY. CONTACT THE ENGINEER OF RECORD FOR THE REQUIREMENTS OF THE AS-BUILT SURVEY BEFORE START OF CONSTRUCTION.

SITE DIMENSION PLAN 1 : 20'

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**KEYED NOTES**

1. EXISTING ROOF ACCESS LADDER.
2. HAND SINK W/ INTEGRAL SPLASH GUARD.
3. G.C. TO REVERSE HINGE ON U.C. REFRIGERATOR TO LEFT HAND SWING AS SHOWN.
4. INSTALL NITRO EQUIPMENT AS INDICATED.
5. LOCATION OF FUTURE 3RD BAR.
6. SAFE LOCATED AT POS CABINET.
7. LOCATION OF ALL SWITCHING.
8. PLACE FIRE EXTINGUISHER IN WORKROOM PER FIRE INSPECTOR.
9. REFER TO ENLARGED RESTROOM PLANS AND ELEVATIONS (SHEET I-401) FOR FIXTURE LOCATIONS AND MOUNTING HEIGHTS.
10. MANAGERS DESK. SEE MANAGER'S DESK / EQUIPMENT RACK ELECTRICAL DETAIL FOR ADDITIONAL INFORMATION.
11. VENDOR TO INSTALL WATER FILTRATION SYSTEM PER MANUFACTURER'S REQUIREMENTS. G.C. TO PROVIDE PLUMBING AND ELECTRICAL REQUIREMENTS.
12. WATER HEATER LOCATION. SEE PLUMBING DRAWINGS.
13. RECESSED ELECTRICAL PANELS. SEE BUILDING FLOOR PENETRATION PLAN ON SHEET A-102 AND ELECTRICAL FOR ADDITIONAL INFORMATION.
14. SECURE LOCKERS TO WALL PER MFGS. RECOMMENDATIONS.
15. EXISTING PATIO RAILING.
16. EXISTING HOSE BIB.
17. INSTALL NEW BIKE RACK.
18. LOCATION OF FUTURE 3RD WARMING OVEN.
19. HOT WATER RECIRC PUMP LOCATION. SEE PLUMBING DRAWINGS.
20. GC TO ORDER AND INSTALL RHINO WET WASTE INTERCEPTOR AT 3-COMP SINK. SPECIFICATION: RHINO UNIT RHG-002.
21. GC TO ORDER AND INSTALL RHINO WET WASTE INTERCEPTOR OR EQUIVALENT ON INDIRECT WASTE PIPE. SEE P-112 FOR MORE INFORMATION.

**GENERAL NOTES**

- A. GENERAL CONTRACTOR TO SCHEDULE WITH LOCAL REFRIGERATION CONTRACTOR TO CONDUCT INITIAL FOOD CASE START-UP AND TESTING. FOR LIST OF APPROVED START UP CONTRACTORS, CONTACT PROJECT CONSTRUCTION REPRESENTATIVE.
- B. THE SITE IS SERVED BY THE MUNICIPAL WATER AND SEWER SYSTEM UNLESS OTHERWISE NOTED.
- C. ALL FLOOR AND WALL JUNCTIONS IN STORAGE AND PREP AREAS SHALL HAVE A 6" COVED BASE.
- D. ALL FOOD STORAGE SHALL BE 6" (150mm) A.F.F.
- E. ALL WOOD SURFACES (DOORS, TRIM, SHELVES, CABINETS) SHALL BE SEALED.
- F. FLOORS, WALLS AND CEILING FINISHES IN FOOD PREP AREAS SHALL BE SMOOTH, NON-TOXIC, NON-ABSORBENT, DURABLE AND EASILY CLEANABLE. PAINT SHALL BE WASHABLE AND SEMI-GLOSS OR HIGH-GLOSS FINISH.
- G. ALL EQUIPMENT AND INSTALLATION WILL MEET NATIONAL SANITATION FOUNDATION STANDARDS OR EQUIVALENT.
- H. ALL EQUIPMENT AND CABINETRY WILL BE FLUSH MOUNTED TO COUNTERS, WALLS OR FLOORS, OR BE RAISED TO ALLOW FOR CLEANING.
- I. CONFIRM ALL NECESSARY CLEARANCES PER PRODUCT CUT SHEET REQUIREMENTS FOR ALL EQUIPMENT (E.G. ICE MACHINE).
- J. EQUIPMENT UNITS SHALL CONTAIN NO EXPOSED THREADS, EMBELLISHMENTS OR OVERHANGING EDGES THAT SERVE AS PLACES FOR ACCUMULATION OF DUST, DIRT AND DEBRIS.
- K. WARMING OVEN(S) SHOWN FOR PERMITTING PURPOSES. INSTALLATION AT STORE OPENING TO BE VERIFIED BY STARBUCKS CONSTRUCTION REPRESENTATIVE.
- L. EACH HAND WASHING SINK WILL HAVE A SINGLE SERVICE TOWEL AND SOAP DISPENSER, AND ALL HAND SINKS TO HAVE A COMBINATION FAUCET OR PREMIXING FAUCET.
- M. FOR PLUMBING FIXTURES, REFER TO THE PLUMBING DESIGN PLAN. FOR DATA DEVICE SCHEDULE, REFER TO THE ELECTRICAL DESIGN PLAN.
- N. SEE ELEVATIONS FOR DISTRIBUTION OF CUP DISPENSERS.

**NOTE:**  
REFER SHEET I-101.1 FOR DATA DEVICE, FURNITURE, GRAPHICS, PLUMBING FIXTURE, SPECIALTY EQUIPMENT, MECHANICAL EQUIPMENT AND SITE SCHEDULE.

REVIEWED FOR CODE COMPLIANCE  
Wade Thorne - PX3005 11-09-23  
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11/06/2023

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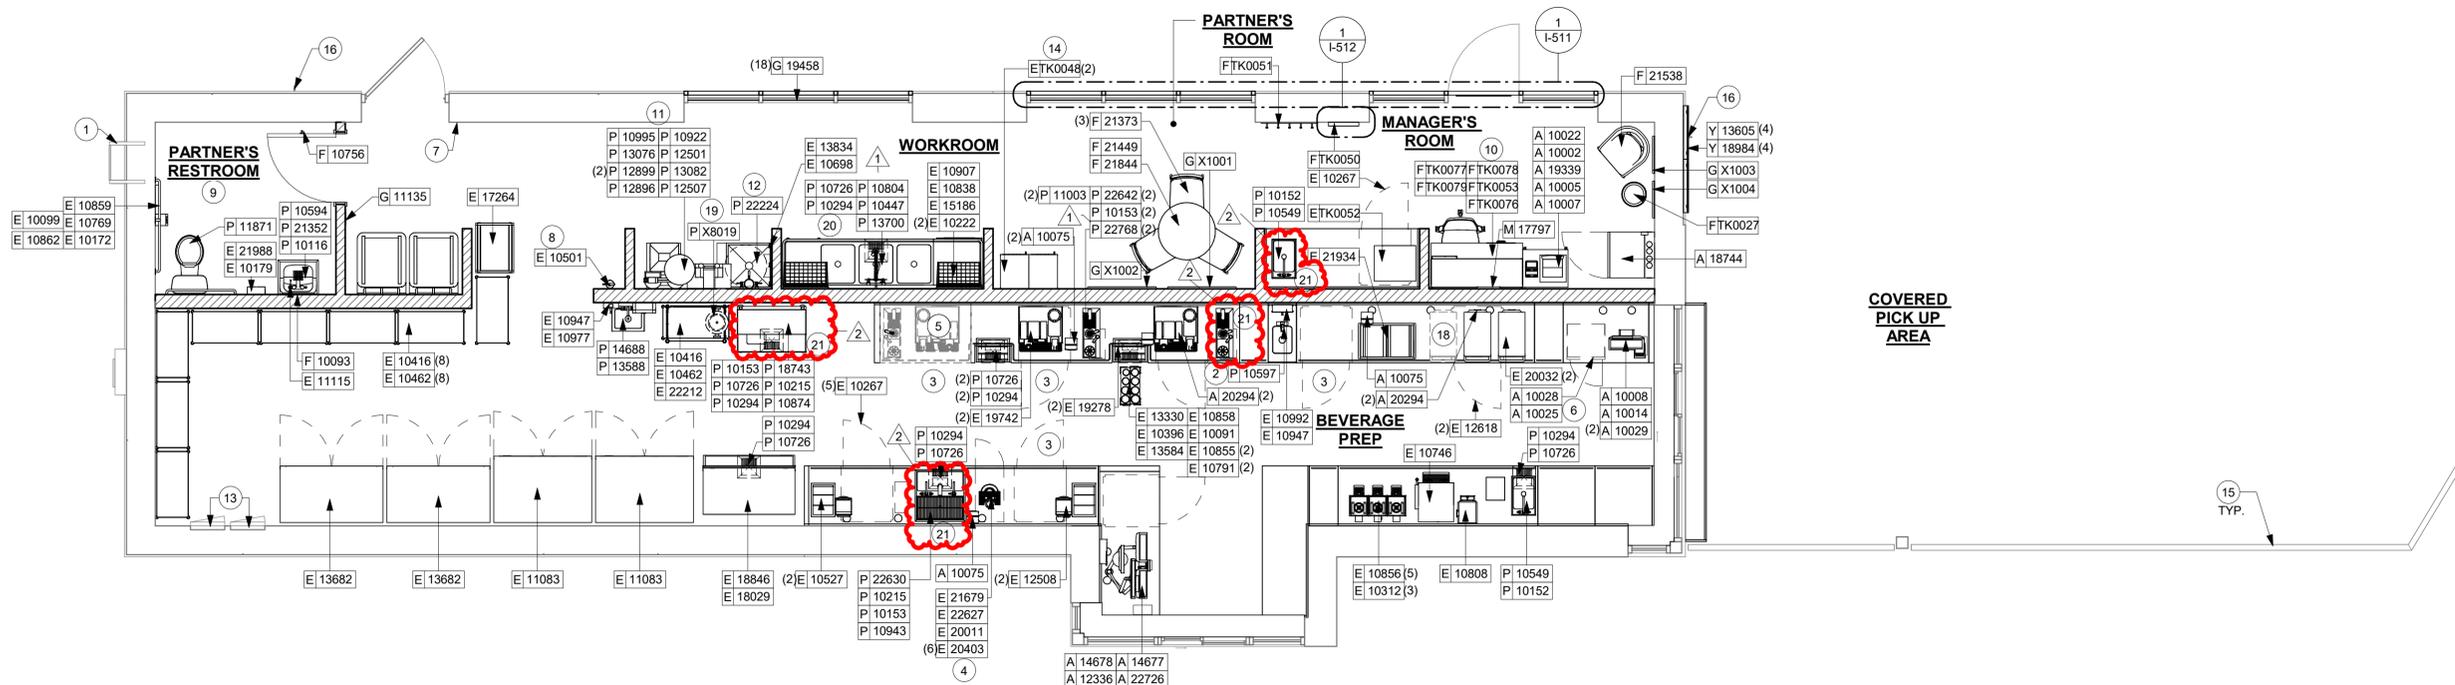
STORE #: 81065  
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DESIGNER: PAULINA LOPEZ  
PRODUCTION DESIGNER: ANDY MCLLOUD  
CHECKED BY: DONALD RETHMAN

Revision Schedule				
Rev	Date	By	Description	
1	09/27/23		Revision 1	
2	11/03/23		Revision 2	


SHEET TITLE:  
**FF & E PLAN**

SCALE: 1/4" = 1'-0"

SHEET NUMBER:  
**I-101**



**1 FURNITURE, FIXTURES AND EQUIPMENT PLAN**  
Scale: 1/4" = 1'-0"

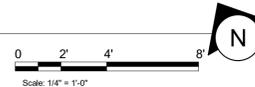

DATA DEVICE SCHEDULE - "A"
DESIGN ID COUNT DESCRIPTION FURN. BY INST. BY COMMENTS
AUDIO VISUAL
10005 1 MUSIC SYSTEM SB VD
10012 1 DT COMMUNICATION SYSTEM SB VD
10013 3 DT QUEUE CAMERA SB VD
10015 3 SPEAKER RECESSED - WHITE SB GC
10017 2 SPEAKER SURFACE MOUNTED SB GC BLACK EXTERIOR
12336 1 DT TIMER SYSTEM SB VD
19339 1 AMPLIFIER - 40W SB VD
22549 3 SPEAKER GRILLE RECESSED - BLACK SB GC
22725 1 DT DIGITAL PRODUCTION MONITOR SB VD PART OF RETAIL IT EQUIPMENT PACKAGE
22726 1 DT POS MONITOR ARM TRIPLE SURFACE MOUNTED SB VD PART OF RETAIL IT EQUIPMENT PACKAGE
DATA
10002 1 COMPUTER MANAGER WORKSTATION SB VD
10007 1 PRINTER MANAGER WORKSTATION SB VD
18744 1 EQUIPMENT RACK WITH LOCK - 24IN 610MM SB GC
20294 4 IOT MODULE SB GC
POINT OF SALE
10008 1 POS - REGISTER WITH COMPACT CASH DRAWER SB VD
10014 2 POS PRINTER SB VD
10022 1 MONEY COUNTER SB VD
10029 4 POS BANK SB GC
10075 4 CUP LABELER SB VD
14677 1 POS - DT TENDERING REGISTER SB VD PART OF RETAIL IT EQUIPMENT PACKAGE
14678 1 POS - DT EXPEDITOR SB VD PART OF RETAIL IT EQUIPMENT PACKAGE
SECURITY
10025 1 SAFE RH - 20X18X26IN 510X455X660MM SB GC
10028 1 SAFE BASE SB GC

FURNITURE SCHEDULE - "F"
DESIGN ID COUNT DESCRIPTION FURN. BY INST. BY COMMENTS
CHAIR
21373 3 CHAIR - CAFE PEGGY UPHOLSTERED - WALNUT AND CARAMEL BROWN NATURAL W0007 F0008 SB GC
21538 1 CHAIR - CAFE DAPHNE UPHOLSTERED - BLACK AND CARAMEL BROWN NATURAL W0003 F0008 SB GC
TK0077 1 CHAIR - MANAGERS WORKSTATION SB GC STEELCASE SERIES ONE ARMLESS
DESK
TK0053 1 DESK - MANAGERS WORKSTATION SHELVES 48IN 1220MM SB GC
TK0076 1 DESK - MANAGERS WORKSTATION - 48X24X27IN 1220X610X685MM SB GC
MIRROR
10093 1 MIRROR - RESTROOM - 18X30IN 455X760MM SB GC
TK0050 1 MIRROR - BOH - 16X51IN 405X1295MM SB GC SEE DETAIL: 1/I-512
OTHER
10756 1 COAT HOOK 1 PRONG SQUARE - 2IN 50MM - SST SB GC
TK0051 1 COAT HOOK STRIP - 30IN 760MM SB GC BLACK FINISH
STORAGE
TK0078 1 FILE MOBILE PEDESTAL WITH CUSHION AND LOCK SB GC
TK0079 1 MANAGERS DESK CART - 24X20IN 610X510MM SB GC
TABLE
21449 1 TABLE - BASE CAFE HEIGHT BOTTLE - FLAT BLACK MT0028 SB GC
21844 1 TABLE - TOP ROUND EDGE ROUND - 30IN 760MM - WALNUT W0007 SB GC
TK0027 1 TABLE - OCCASIONAL SIDE COCO SB GC CONTACT: TRADE@BLUDOT.COM
WINDOW TREATMENT
22486 9 ROLLER SHADE - DARK BROWN - 5PC OPEN SB VD LENGTH TO ALIGN WITH BOTTOM MULLION; LENGTH REQUIRED: (9) 3' - 1 1/4" LENGTH

GRAPHICS AND ARTWORK SCHEDULE - "G"
DESIGN ID COUNT DESCRIPTION FURN. BY INST. BY COMMENTS
GRAPHIC - FILM
19458 18 INTERIOR WINDOW FILM FASARA - DUSTED CRYSTAL SB GC SIZE REQUIRED: (V.I.F.): (8) 3' - 1 1/4" W X 6' - 10" H (9) 3' - 1 1/4" W X 2' - 8" H (1) 2' - 4 3/4" W X 5' - 9 1/2" H
GRAPHICS - ARTWORK
X1001 1 SBXART\_22711 - WRAPPED CANVAS IN FLOAT FRAME; ART SIZE: 35" W X 35" H; REVEAL .25" - PRINT TO EDGES - PRINT EDGES BLACK - OVERALL SIZE: 36" W X 36" H - CANVAS 1; FRAME: 3A - FRAME 623674 EBONIZED WALNUT SB GC SEE ELEVATION: 1/I-203
X1002 1 SBXART\_22679 - WRAPPED CANVAS IN FLOAT FRAME; ART SIZE: 35" W X 35" H; REVEAL .25" - PRINT TO EDGES - PRINT EDGES BLACK - OVERALL SIZE: 36" W X 36" H - CANVAS 1; FRAME: 3A - FRAME 623674 EBONIZED WALNUT SB GC SEE ELEVATION: 1/I-203
X1003 1 SBXART\_16969 - FRAMED AND MATTED; ART SIZE: 12" W X 12" H; MAT BORDER 3IN; OVERALL SIZE: 19 1/2" W X 19 1/2" H; PAPER 1 - MAT 1 - FRAME 1A (EBONIZED WALNUT) SB GC SEE ELEVATION: 6/I-202
X1004 1 SBXART\_22483 - FRAMED AND MATTED; ART SIZE: 12" W X 12" H; MAT BORDER 3IN; OVERALL SIZE: 19 1/2" W X 19 1/2" H; PAPER 1 - MAT 1 - FRAME 1A (EBONIZED WALNUT) SB GC SEE ELEVATION: 6/I-202
GRAPHICS - OTHER
11135 1 RESTROOM SIGN UNISEX ACCESSIBLE SB GC

MECHANICAL EQUIPMENT SCHEDULE - "M"
DESIGN ID COUNT DESCRIPTION FURN. BY INST. BY COMMENTS
OTHER
17797 1 ENERGY MANAGEMENT SYSTEM - HVAC ONLY SB GC

SPECIALTY EQUIPMENT SCHEDULE - "E"
DESIGN ID COUNT DESCRIPTION FURN. BY INST. BY COMMENTS
COOLING
10267 6 FRIDGE UNDERCOUNTER 1 DOOR - 27IN 685MM SB GC
11083 2 FRIDGE REACH IN 2 DOOR - 51X35IN 129X890MM SB GC
12618 2 FRIDGE UNDERCOUNTER 1 DOOR WITH SHELF - 27IN 685MM SB GC
13682 2 FREEZER REACH IN 2 DOOR - 54IN 1370MM SB GC
20011 1 FRIDGE NITRO 2 TAP JT NITCOM RH SB GC KIT INCLUDES UNDERCOUNTER FRIDGE, FONT, TRAY, AND TUBING
EQUIPMENT
10312 3 BREWER SOFT HEAT WARMING STAND SINGLE SB GC
10746 1 BREWER DUAL SOFT HEAT SB GC
10808 1 GRINDER DITTING KR1203 SB GC
10856 5 BREWER SERVER SOFT HEAT SB GC
10907 1 DISHWASHER LEGS AND SKIRT SB GC
12508 2 BLENDER QUIET MODEL ON COUNTER SB GC
15186 1 DISHWASHER LXER ADVANSYS SB GC
19742 2 ESPRESSO MACHINE MASTRENA II SB GC
20032 2 OVEN EIKON E2S - BLACK SB GC
21679 1 NITROGEN GENERATOR ELEMENT COMPACT SB GC
TK0052 1 OVEN SAMSUNG MICROWAVE MS14K6000AS - STAINLESS STEEL SB GC
ICE
10527 2 ICE - BIN DROP IN 45LB 20KG SB GC
18029 1 ICE - BIN B110 SB GC BPF-1 ADAPTER KIT (011076103) REQUIRED WHEN PAIRING WITH 30" (760MM) ICE MACHINES
18846 1 ICE - MACHINE CIM1446HR SERIES REMOTE COOLED SB GC
19278 2 ICE - BIN DROP IN 45LB 20KG HORIZONTAL SB GC
OTHER
10091 1 CUP DISPENSER TALL HOT VERTICAL SB GC
10099 1 RESTROOM TOILET PAPER HOLDER SB GC
10172 1 RESTROOM SEAT COVER DISPENSER SB GC
10179 1 HAND DRYER SURFACE MOUNTED SB GC
10396 1 CUP DISPENSER SHORT HOT VERTICAL SB GC
10501 1 FIRE EXTINGUISHER GC GC SPEC: MANUFACTURER: PRODUCT PRO 460; PART #21005785; MULTIPURPOSE DRY-CHEMICAL TYPE UL RATED 4-A, 60-B-C, 10LB; METAL STRAP BRACKET PART # 366242
10769 1 RESTROOM GRAB BAR VERTICAL - 18IN 455MM SB GC
10791 2 CUP DISPENSER GRANDE VENTI COLD VERTICAL SB GC
10855 2 CUP DISPENSER GRANDE VENTI HOT VERTICAL SB GC
10858 1 CUP DISPENSER TALL COLD VERTICAL SB GC
10859 1 RESTROOM GRAB BAR - 48IN 1220MM SB GC
10862 1 RESTROOM GRAB BAR - 36IN 915MM SB GC
10947 2 SOAP DISPENSER WALL MOUNTED SB GC
10977 1 PAPER TOWEL DISPENSER FULL SIZE SB GC
10992 1 PAPER TOWEL DISPENSER HALF SIZE - TRANSLUCENT GRAY SB GC
11115 1 SOAP DISPENSER SINK MOUNTED SB GC
13330 1 MOBILE CUP DISPENSER CADDY SB GC
13584 1 CUP DISPENSER TRENTA COLD VERTICAL SB GC
20403 6 KEG - 3GAL SB GC
21988 1 HAND DRYER BACK PANEL SB GC
22627 1 NITRO 2 TAP HANDLE WITH BADGE AND MOUNT KIT SB GC JOE TAP, FOR USE AT BACKBAR NITRO FONT
STORAGE
10222 2 WIRE SHELF GRID AT SINK SB GC
10416 9 WORKROOM SHELVING - 36IN 915MM SB GC
10462 9 WORKROOM SHELVING POSTS SB GC
10698 1 MOP RACK WITH 3 HOLDERS SB GC
10838 1 ROLLING WIRE CART FOR 3 COMP SINK SB GC
13834 1 BASE - 24X18IN 610X455MM SB GC
17264 1 ROLLING PASTRY TRAY THAW RACK - 20X26IN 510X660MM SB GC
21934 1 PASTRY TRAY RACK UNDERCOUNTER - 30IN 760MM SB GC
22212 1 WORKROOM SHELVING CART KIT SB GC
TK0048 2 5 COMP LOCKER - 15IN 380MM SB GC

SITE SCHEDULE - "Y"
DESIGN ID COUNT DESCRIPTION FURN. BY INST. BY COMMENTS
EXTERIOR MENU
13605 4 MENU BOARD - WALK UP - 28X21IN 710X535MM SB VD
18984 4 MENU BOARD - UNIVERSAL WALL MOUNT BRACKET SB GC
22540 1 MENU BOARD - DT 5 PANEL SQUARE FRAME FREESTANDING - 95X62IN 2415X1575MM - BLACK SB VD SEE DETAIL: 1/APX-103
22542 1 MENU BOARD - DT PRE MENU SQUARE FRAME FREESTANDING - 29X61IN 735X1550MM - BLACK SB VD SEE DETAIL: 3/APX-103
22546 1 MENU BOARD - DT DIGITAL ORDER SCREEN WITH POST - BLACK SB VD SEE DETAIL: 1/APX-103.2
OTHER
10042 2 BIKE RACK HOOP EXIST EXIST SEE DETAIL: 10 & 11/APX-104
10163 1 DT WINDOW SHELF - 56IN OBSIDIAN PAPERSTONE EXIST EXIST SEE DETAIL: 4/APX-103.1
14095 1 DT WAYFINDING GRAPHIC EXIT ARROW - WHITE EXIST EXIST SEE DETAIL: 9/APX-104
14101 1 DT WAYFINDING GRAPHIC ENTRY ARROW - GREEN EXIST EXIST SEE DETAIL: 8/APX-104
14323 2 DT WAYFINDING GRAPHIC DIRECTIONAL DOUBLE ARROW - GREEN EXIST EXIST REFERENCE PAINT P936 FOR SPECIFICATIONS; SEE DETAIL: 6/APX-104
14324 2 DT WAYFINDING GRAPHIC DIRECTIONAL DOUBLE ARROW - WHITE EXIST EXIST REFERENCE PAINT P935 FOR SPECIFICATIONS; SEE DETAIL: 6/APX-104
22543 1 DT ORDER POINT CANOPY SQUARE FRAME - BLACK SB VD SEE DETAIL: 2/APX-103.2
X4001 4 CIRCULAR BOLLARD - 6" DIA EXIST EXIST SEE DETAIL: 1/APX-104
X4002 1 PATIO RAILING EXIST EXIST SEE DETAIL: 4/APX-105
X4003 1 LOUVERS AT STOREFRONT - LINEAR SUNSHADES #543 MEDIUM BRONZE SB VD SEE DETAIL: 1/I-511; VD: SUN CONTROL SOLUTIONS; WWW.C-SGROUP.COM
X4004 2 LOUVERS AT STOREFRONT - LINEAR SUNSHADES #543 MEDIUM BRONZE SB VD SEE DETAIL: 1/I-511; VD: SUN CONTROL SOLUTIONS; WWW.C-SGROUP.COM

RESPONSIBILITY LEGEND

FURN. BY INST. BY
SB - FURNISHED BY STARBUCKS GC - INSTALLED BY GENERAL CONTRACTOR
GC - FURNISHED BY GENERAL CONTRACTOR SB - INSTALLED BY STARBUCKS
VD - FURNISHED BY VENDOR VD - INSTALLED BY VENDOR

NOTE: ALL RESPONSIBILITIES TO BE CONFIRMED WITH STARBUCKS CONSTRUCTION MANAGER PRIOR TO ORDERING / CONSTRUCTION.

REVIEWED FOR CODE COMPLIANCE
Wagne Thorne - PX3005 11-09-23
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PLUMBING FIXTURE SCHEDULE - "P"
DESIGN ID COUNT DESCRIPTION FURN. BY INST. BY COMMENTS
DRAIN
10294 7 DRAIN - FLOOR SINK SQUARE - 12IN 305MM SB GC
10594 1 DRAIN - FLOOR SINK SQUARE - 5IN 125MM GC GC ZURN ZN415B
10726 7 DRAIN - GRATE HALF SQUARE - 12IN 305MM SB GC
EQUIPMENT
X8019 1 HOT WATER RECIRCULATION PUMP SB GC BELL & GOSSETT MODEL NBF-36 PUMP WITH BELL & GOSSETT AQS-3/4 AQUASTAT, AND BELL & GOSSETT TC-1 AUTOMATIC TIMER
FAUCET
10152 2 FAUCET - DOUBLE LABORATORY WITH BENT RISER SPOUT SB GC
10153 4 FAUCET - WATER TOWER - 12IN 305MM SB GC
10215 2 FAUCET - DOUBLE LABORATORY WITH SWING SPOUT SB GC
10447 1 FAUCET - PRE RINSE SPRAYER WALL MOUNTED SB GC
10597 1 FAUCET - SINGLE HANDLE SB GC
10804 1 FAUCET - PRE RINSE SWING SPOUT SB GC
10874 1 FAUCET - INSTAHOT SYSTEM SINGLE LEVER SB GC
10922 1 FAUCET - MOP SINK WALL MOUNTED SB GC
10943 1 FAUCET - SINGLE LABORATORY WITH SWING SPOUT SB GC
11003 2 FAUCET - METERED SB GC
13588 1 FAUCET - HAND SINK WALL MOUNTED SB GC
21352 1 FAUCET - RESTROOM WITH MOTION SENSOR SB GC
22642 2 FAUCET - INSTANTHOT SYSTEM 2 BUTTON WITH BOILER AND BRACKET SB GC KIT INCLUDES FONT, UNDERCOUNTER BOILER AND BOILER BRACKET FOR SIDE PANEL MOUNTING. BRACKET CAN BE FLOOR MOUNTED USING SET OF (4) STAINLESS STEEL LEGS, ORDERED SEPARATELY THROUGH VENDOR.
FILTER
12501 1 FILTER - RO SYSTEM 600GPD SB VD
12507 1 FILTER - RO SYSTEM STORAGE TANK RO40 SB VD
12896 1 FILTER - BRINE TANK SB VD
12899 2 FILTER - POLY GLASS VESSEL SB VD
13076 1 FILTER - PREFILTRATION SYSTEM SB VD
13082 1 FILTER - WATER SOFTENER TWIN SB VD
OTHER
22224 1 WATER HEATER TANK ELECTRIC - 13.5W SB GC 13.5KW 208/3 BRADFORD WHITE E32-50S-3 30GAL ELECTRIC
SINK
10116 1 SINK - RESTROOM WALL MOUNTED SB GC
10549 2 SINK - RINSE DROP IN SST - 12X20IN 305X510MM SB GC
10995 1 SINK - MOP - 24X24IN 610X610MM SB GC
13700 1 SINK - 3 COMP WORK SST - 105IN 2665MM SB GC
14688 1 SINK - HAND WITH SIDE SPLASH WALL MOUNTED SST SB GC
18743 1 SINK - WATER FILLING STATION - 36X24IN 915X610MM SB GC
22630 1 SINK - RINSE DROP IN - 27X26IN 685X670MM SB GC
22768 2 SINK - COUNTERTOP RINSE WITH WATER TOWER - 26X9IN 660X235MM SB GC
TOILET
11871 1 TOILET - WITH TANK SINGLE FLUSH GC GC WC TO BE PURCHASED THROUGH FERGUSON; NA.PROJECTS@FERGUSON.COM

FOR CONSTRUCTION



STARBUCKS
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STARBUCKS TEMPLATE VERSION: I2021-09-13

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Design Forum Engineering

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PROJECT NAME: US 17-92 & LAKE MARY BLVD

PROJECT ADDRESS: 3764 ORLANDO DRIVE SANFORD, FL 32773

STORE #: 81065
PROJECT #: 98504-001
ISSUE DATE: 08-03-2023
DESIGNER: PAULINA LOPEZ
PRODUCTION DESIGNER: ANDY MCLLOUD
CHECKED BY: DONALD RETHMAN

Revision Schedule table with columns: Rev, Date, By, Description

SHEET TITLE: FF & E SCHEDULES

SCALE: NO SCALE

SHEET NUMBER: I-101.1



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ADAPTABLE CASEWORK SUPPORT LEG AND DIEWALL BASE SCHEDULE "C"					
DESIGN ID	COUNT	DESCRIPTION	FURN. BY	INST. BY	COMMENTS
DIEWALL					
21888	46	DIEWALL - SUPPORT LEG	SB	GC	

**REVIEWED FOR CODE COMPLIANCE**  
 Wayne Thorne - PX3005 11-09-23  
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Timothy L. Raberding, PE  
 Professional Engineer  
 License: 62078



**FOR CONSTRUCTION**

PROJECT NAME:  
**US 17-92 & LAKE MARY BLVD**


PROJECT ADDRESS:  
**3764 ORLANDO DRIVE  
 SANFORD, FL 23773**

STORE #: 81065  
 PROJECT #: 98504-001  
 ISSUE DATE: 08-03-2023  
 DESIGNER: PAULINA LOPEZ  
 PRODUCTION DESIGNER: ANDY MCLLOUD  
 CHECKED BY: DONALD RETHMAN

Revision Schedule			
Rev	Date	By	Description

SHEET TITLE:  
**ADAPTABLE CASEWORK BASE PLAN**

SHEET NUMBER:  
**I-102.1**

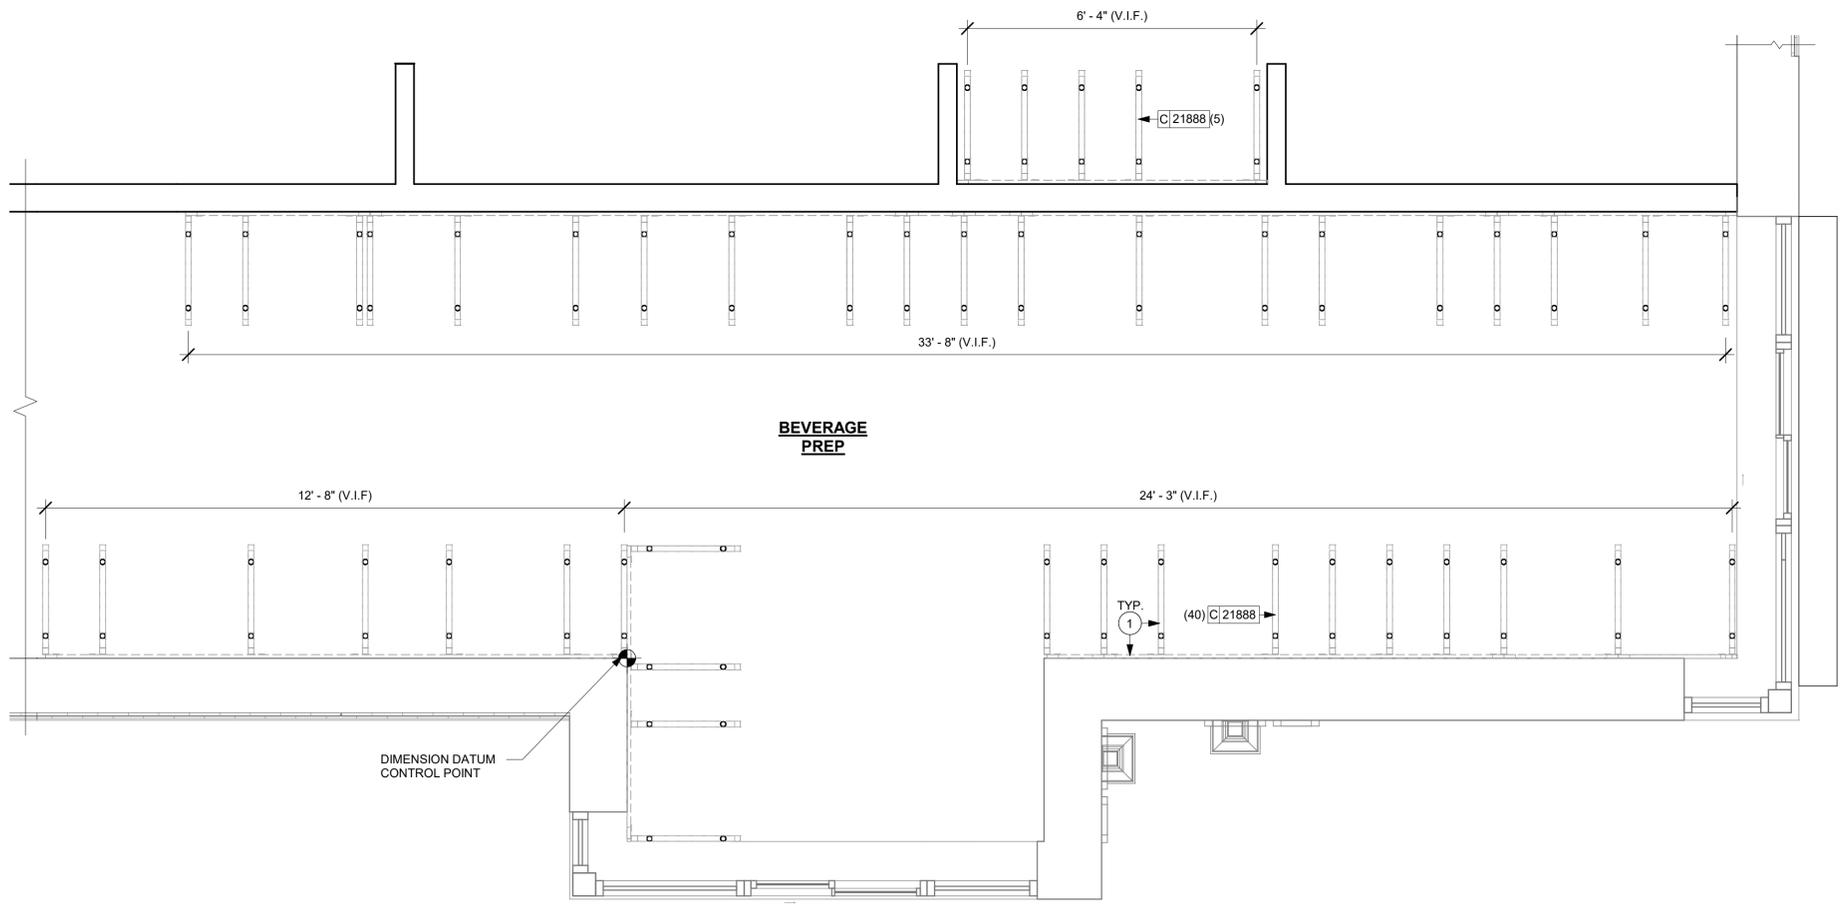

**GENERAL NOTES**

- A. SEE SHEET I-103 FOR COMPLETE CASEWORK SCHEDULE.
- B. METAL COMPONENTS PROVIDED BY CASEWORK SUPPLIER UNLESS OTHERWISE NOTED.
- C. DIEWALL AND BOX BASES TO BE INSTALLED PRIOR TO FLOORING MATERIAL INSTALLATION.
- D. G.C. TO INSTALL BLOCKING BETWEEN DIEWALL BASE.
- E. ALL DIMENSIONS TAKEN FROM FRONTLINE DATUM POINT TO OUTSIDE CORNER OF DIEWALL BASE.
- F. BOX BASE (IF APPLICABLE) BUTTS UP AGAINST INSIDE FACE OF DIEWALL. PROVIDE SEALANT AT SEAM.
- G. LEVEL BOX BASES TO BOTTOM RAIL OF WALL FRAME.


**KEYED NOTES**

- 1. CASEWORK FRAMEWORK ABOVE.

**LEGEND**

- VARIABLE LENGTH BOX BASE
- CABINET LEG
- DATUM POINT

**1 ADAPTABLE CASEWORK BASE PLAN**  
 Scale: 1/2" = 1'-0"

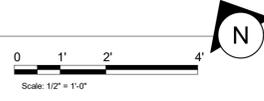

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ADAPTABLE CASEWORK FRAMEWORK SCHEDULE - "C"					
DESIGN ID	COUNT	DESCRIPTION	FURN. BY	INST. BY	COMMENTS
21885	15	DIEWALL - FRAMING - VARIABLE LENGTH	SB	GC	
21888	46	DIEWALL - SUPPORT LEG	SB	GC	

**REVIEWED FOR CODE COMPLIANCE**  
 Wayne Thorne - PX3005 11-09-23  
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 Timothy L. Raberding, PE  
 Professional Engineer  
 License: 62078



**FOR CONSTRUCTION**

PROJECT NAME:  
**US 17-92 & LAKE MARY BLVD**


PROJECT ADDRESS:  
**3764 ORLANDO DRIVE  
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STORE #: 81065  
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 ISSUE DATE: 08-03-2023  
 DESIGNER: PAULINA LOPEZ  
 PRODUCTION DESIGNER: ANDY MCLLOUD  
 CHECKED BY: DONALD RETHMAN


Revision Schedule			
Rev	Date	By	Description

SHEET TITLE:  
**ADAPTABLE CASEWORK FRAMEWORK PLAN**

SHEET NUMBER:  
**1-102.2**

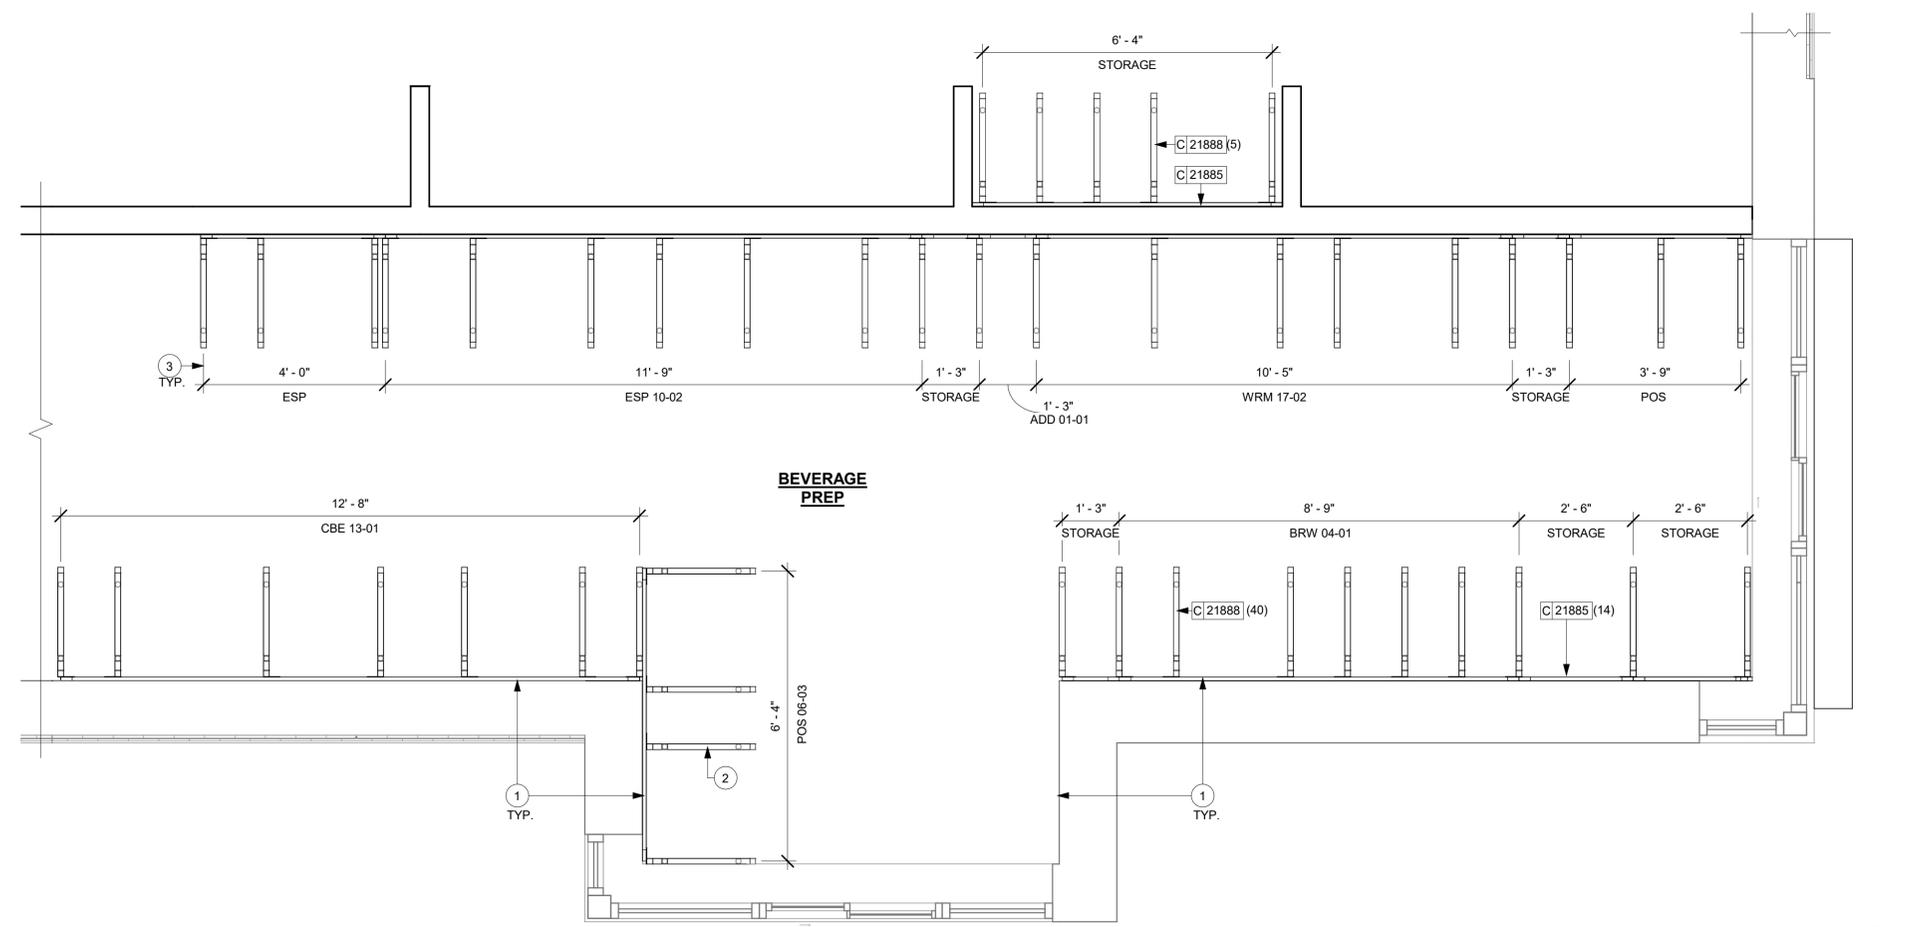

**1 ADAPTABLE CASEWORK FRAMEWORK PLAN**  
 Scale: 1/2" = 1'-0"

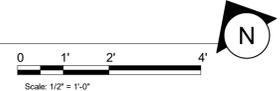

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ADAPTABLE CASEWORK CABINET SCHEDULE - "C"					
DESIGN ID	COUNT	DESCRIPTION	FURN. BY	INST. BY	COMMENTS
CABINET					
17580	2	CABINET - CBE TEA SHELF - 29IN 735MM - FLAT BLACK MT0028	SB	GC	PROVIDED BY CASEWORK VENDOR
19281	2	CABINET - ESPRESSO ICE BIN STAINLESS - 20IN 510MM	SB	GC	
21890	33	CABINET - SIDE PANEL	SB	GC	
21891	13	CABINET - BOTTOM SHELF - 15IN 380MM	SB	GC	
21892	8	CABINET - BACK PANEL - 15IN 380MM	SB	GC	
21893	8	CABINET - ADJUSTABLE SHELF - 15IN 380MM	SB	GC	
21894	12	CABINET - DOOR - 15IN 380MM	SB	GC	FINISH: CP0024
21895	6	CABINET - DOOR TRASH - 15IN 380MM	SB	GC	FINISH: CP0024
21896	1	CABINET - DRAWER - 15IN 380MM	SB	GC	FINISH: CP0024
21898	1	CABINET - BOTTOM SHELF - 18IN 455MM	SB	GC	
21901	1	CABINET - DOOR - 18IN 455MM	SB	GC	FINISH: CP0024
21902	6	CABINET - BOTTOM SHELF - 30IN 760MM	SB	GC	
21903	4	CABINET - BACK PANEL - 30IN 760MM	SB	GC	
21904	6	CABINET - ADJUSTABLE SHELF - 30IN 760MM	SB	GC	
21905	5	CABINET - DOOR - 30IN 760MM	SB	GC	FINISH: CP0024
21907	3	CABINET - END CAP BACKBAR	SB	GC	FINISH: CP0024
21908	4	CABINET - FILLER PANEL - VARIABLE LENGTH	SB	GC	FINISH: CP0024; LENGTH REQUIRED: (1) 0' - 2" (1) 0' - 3 1/4"
21909	1	CABINET - DT POS UPPER CUBBY - 32IN 815MM	SB	GC	FINISH: PL0019
21910	1	CABINET - FRENCH CLEAT - VARIABLE LENGTH	SB	GC	OVERALL LENGTH REQUIRED: 2' - 6 1/2"
21912	1	CABINET - BACK PANEL FOR POS - 30IN 760MM	SB	GC	
21913	3	CABINET - EQUIPMENT MOUNTING PANEL	SB	GC	
22632	1	CABINET - CBE DRY INCLUSION SHELF - 44IN 1120MM - FLAT BLACK MT0028	SB	GC	PROVIDED BY CASEWORK VENDOR
22749	1	CABINET - ESPRESSO PUMP MOUNT PANEL	SB	GC	
22980	2	CABINET - ADJUSTABLE SHELF - 21IN 535MM	SB	GC	
22981	1	CABINET - BACK PANEL FOR POS - 21IN 535MM	SB	GC	
22982	1	CABINET - BOTTOM SHELF - 21IN 535MM	SB	GC	
X5006	2	CUSTOM CABINET - BACKBAR - 37.5IN 950MM	SB	GC	FINISH: PL0019; SEE DETAIL: 5/I-508; PROVIDED BY CASEWORK VENDOR
X5013	1	CUSTOM CABINET - BACKBAR COUNTER SUPPORT PANEL - 3IN 75MM	SB	GC	FINISH: PL0019; SEE DETAIL: 3/I-508; SIMILAR TO DID #17573; CUSTOM DUE TO DEPTH; PROVIDED BY CASEWORK VENDOR
OTHER					
10829	11	CORNER GUARD - 75IN 19MM	SB	GC	LOCATED @ BOH SST
11155	2	ESPRESSO MACHINE PUMP MOUNT - 10X10IN 255X255MM	SB	GC	
21914	8	FRIDGE STOP BRACKET SET	SB	GC	
X5007	2	CUSTOM WOOD SHELVES	SB	GC	FINISH: WD0077; SEE DETAIL: 1/I-509; PROVIDED BY CW VENDOR
X5008	1	CUSTOM DT SILL TOP	SB	GC	FINISH: CP0030; SEE DETAIL: 7/I-509; PROVIDED BY CASEWORK VENDOR
X5009	1	CUSTOM PICK UP WINDOW SILL TOP	SB	GC	FINISH: CP0030; SEE DETAIL: 4/I-509; PROVIDED BY CASEWORK VENDOR
X5012	1	CUSTOM PICK UP WINDOW SILL TOP	SB	GC	FINISH: CP0056; SEE DETAIL: 5/I-511; PROVIDED BY CASEWORK VENDOR

ADAPTABLE CASEWORK CABINET SCHEDULE - "C"					
DESIGN ID	COUNT	DESCRIPTION	FURN. BY	INST. BY	COMMENTS
X5016	1	CUSTOM METAL FLAT BAR AT PARTNER'S AREA	SB	GC	FINISH: PAINTED TO MATCH SW7031-ES; SEE DETAIL: 6/A-502; PROVIDED BY CASEWORK VENDOR
X5017	1	CUSTOM METAL FLAT BAR AT WORKROOM	SB	GC	FINISH TO MATCH SW7031-ES; SEE DETAIL: 7/A-502; PROVIDED BY CASEWORK VENDOR
X5018	1	CUSTOM STAND-UP SHELF	SB	GC	FINISH: WD0077; SEE DETAIL: 4/I-512

ADAPTABLE CASEWORK CABINET TYPES AND BILL OF MATERIALS SCHEDULE										
KEY NUMBER	CABINET TYPE	FULL HT. DOORS	3/4 DOOR	3/4 DOOR W/ VENT	DRAWER	BOTTOM SHELF	ADJUST. SHELF	BACK PANEL	SIDE PANELS	BOX BASE**
101	15" STORAGE	1 DID 21894	N/A	N/A	N/A	1 DID 21891	1 DID 21893	1 DID 21892	2** DID 21890	NO
102	18" STORAGE	1 DID 21901	N/A	N/A	N/A	1 DID 21898	1 DID 21900	1 DID 21899	2** DID 21890	NO
103	30" STORAGE	2 DID 21905	N/A	N/A	N/A	1 DID 21902	1 DID 21904	1 DID 21903	2** DID 21890	NO
104	30" POS	N/A	N/A	N/A	N/A	1 DID 21902	2 DID 21904	1 DID 21912	2** DID 21890	NO
105	21" POS	N/A	N/A	N/A	N/A	1 DID 22982	2 DID 22980	1 DID 22981	2** DID 21890	NO
106	15" DRAWER	N/A	1 DID 21895	N/A	1 DID 21896	1 DID 21891	1 DID 21893	1 DID 21892	2** DID 21890	NO
108	15" CUBBY - COFFEE	N/A	N/A	N/A	N/A	1 DID 21891	1 DID 21893	1 DID 21892	2** DID 21890	NO
109	15" CUBBY - TRASH	N/A	1/0" DID 21895	N/A	N/A	N/A	0	0	2** DID 21890	NO
110	15" SINK	1/0" DID 21894	N/A	N/A	N/A	1A DID 21891	0	0	2** DID 21890	NO
111	18" SINK OR ICE BIN	1/0" DID 21901	N/A	N/A	N/A	1A DID 21898	0	0	0 (1,2)** DID 21890	NO
112	24" SAFE	N/A	N/A	N/A	N/A	N/A	0	0	0 (1,2)** DID 21890	NO
113	30" REFRIGERATOR	N/A	N/A	N/A	N/A	N/A	0	0	0 (1,2)** DID 21890	NO

\* DOOR NOT REQUIRED WHERE CUSTOMER VIEW IS LIMITED OR NEGLIGIBLE (I.E. FRONTLINE OR BEHIND WALLS)  
 \*\* SIDE PANEL QUANTITY SHOWN IS FOR STAND-ALONE CABINETS; ACUTAL SIDE PANEL QUANTITY IS DEPENDENT ON ADJACENT...  
 A BOTTOM SHELF AND BOX BASE (IF APPLICABLE), SHOULD BE REMOVED AT SINK/ICE BIN CABINETS WITH FLOOR SINK LOCATED...  
 \*\* BOX BASE TO BE PROVIDED AT SPECIFIC CABINETS WHEN REQUIRED BY JURISDICTIONAL CODE OR LOCAL OPERATOR PREFERENCE (NOTED AS "YES")

**REVIEWED FOR CODE COMPLIANCE**  
 Wayne Thorne - PX3005 11-09-23  
 A PERMIT ISSUED SHALL BE CONSTRUED TO BE A LICENSE TO PROCEED WITH THE WORK AND NOT AS AN AUTHORITY TO VIOLATE, CANCEL, ALTER OR SET ASIDE ANY OF THE PROVISIONS OF THE TECHNICAL CODES, NOR SHALL ISSUANCE OF A PERMIT PREVENT THE BUILDING OFFICIAL FROM THEREAFTER REQUIRING A CORRECTION OF ERRORS IN PLANS, CONSTRUCTION OR VIOLATIONS OF THIS CODE.

**SANFORD**  
 BUILDING DEPARTMENT

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 11/06/2023

**FOR CONSTRUCTION**

PROJECT NAME:  
**US 17-92 & LAKE MARY BLVD**


PROJECT ADDRESS:  
**3764 ORLANDO DRIVE  
 SANFORD, FL 32773**

STORE #: 81065  
 PROJECT #: 98504-001  
 ISSUE DATE: 08-03-2023  
 DESIGNER: PAULINA LOPEZ  
 PRODUCTION DESIGNER: ANDY MCLLOUD  
 CHECKED BY: DONALD RETHMAN


Revision Schedule			
Rev	Date	By	Description

SHEET TITLE:  
**ADAPTABLE CASEWORK CABINET PLAN**  
 SCALE: 1/2" = 1'-0"

SHEET NUMBER:  
**I-102.3**

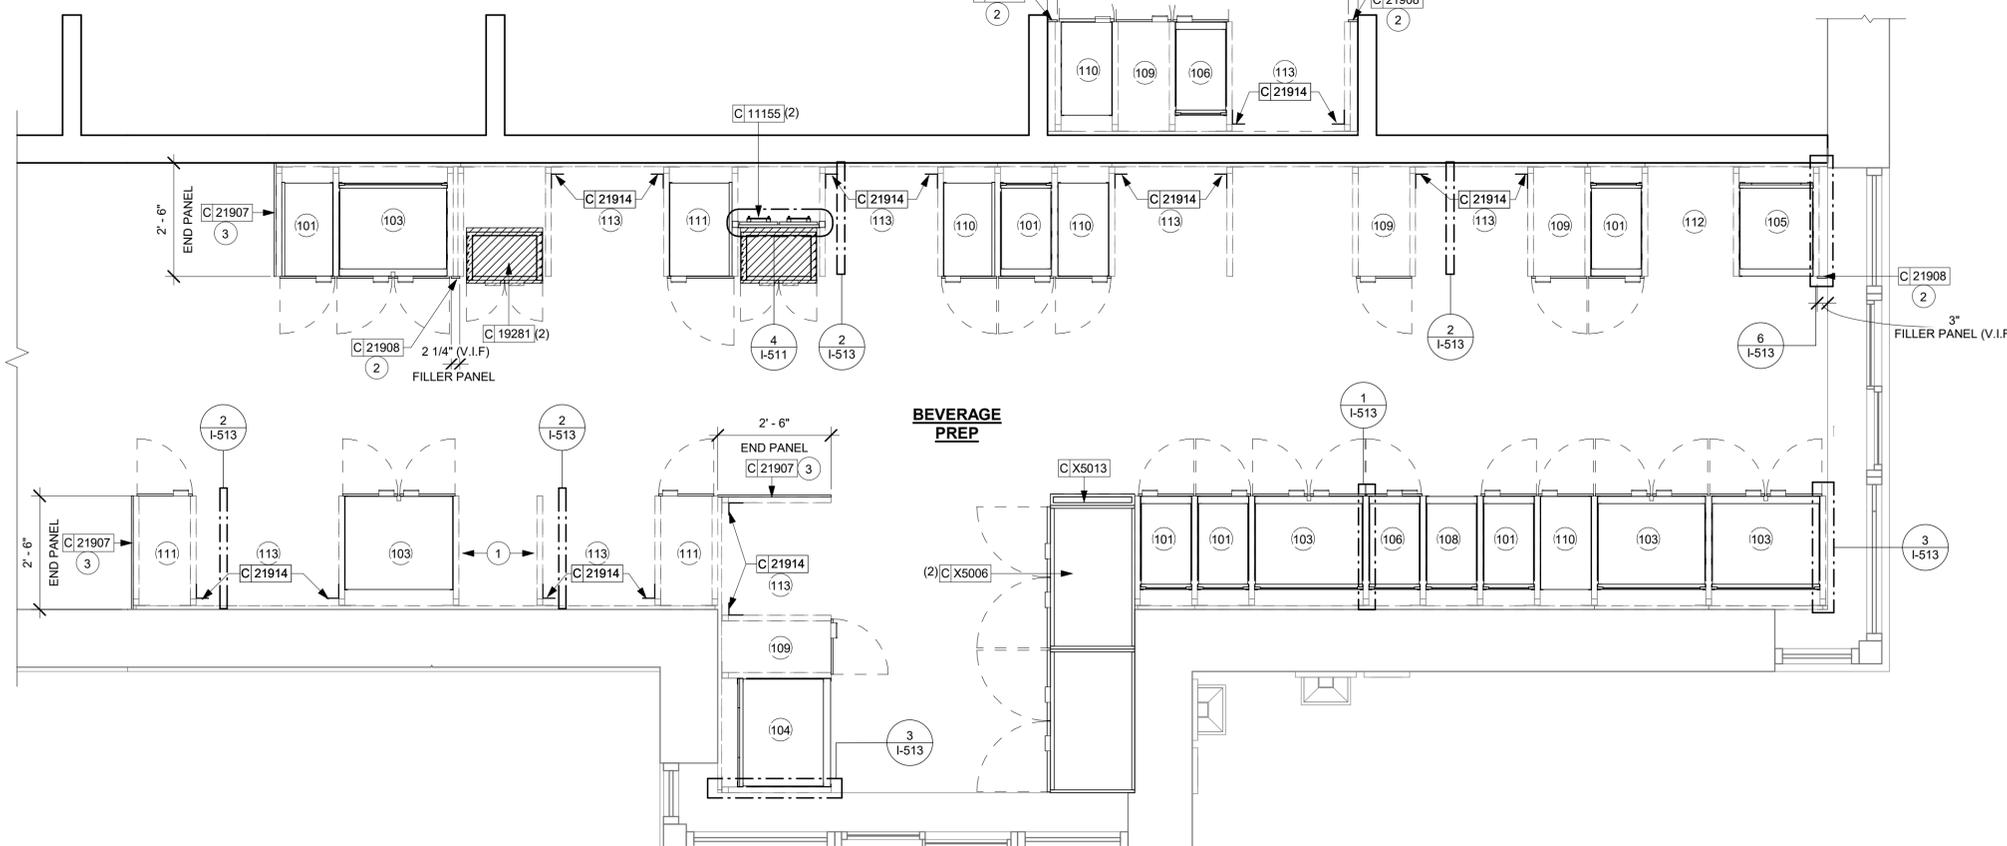

**1 ADAPTABLE CASEWORK CABINET PLAN**  
 Scale: 1/2" = 1'-0"

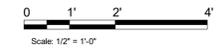



CASEWORK SCHEDULE - "C"					
DESIGN ID	COUNT	DESCRIPTION	FURN. BY	INST. BY	COMMENTS
<b>CABINET</b>					
17580	2	CABINET - CBE TEA SHELF - 29IN 735MM - FLAT BLACK MT0028	SB	GC	PROVIDED BY CASEWORK VENDOR
19281	2	CABINET - ESPRESSO ICE BIN STAINLESS - 20IN 510MM	SB	GC	
21890	33	CABINET - SIDE PANEL	SB	GC	
21891	13	CABINET - BOTTOM SHELF - 15IN 380MM	SB	GC	
21892	8	CABINET - BACK PANEL - 15IN 380MM	SB	GC	
21893	8	CABINET - ADJUSTABLE SHELF - 15IN 380MM	SB	GC	
21894	12	CABINET - DOOR - 15IN 380MM	SB	GC	FINISH: CP0024
21895	6	CABINET - DOOR TRASH - 15IN 380MM	SB	GC	FINISH: CP0024
21896	1	CABINET - DRAWER - 15IN 380MM	SB	GC	FINISH: CP0024
21898	1	CABINET - BOTTOM SHELF - 18IN 455MM	SB	GC	
21901	1	CABINET - DOOR - 18IN 455MM	SB	GC	FINISH: CP0024
21902	6	CABINET - BOTTOM SHELF - 30IN 760MM	SB	GC	
21903	4	CABINET - BACK PANEL - 30IN 760MM	SB	GC	
21904	6	CABINET - ADJUSTABLE SHELF - 30IN 760MM	SB	GC	
21905	5	CABINET - DOOR - 30IN 760MM	SB	GC	FINISH: CP0024
21907	3	CABINET - END CAP BACKBAR	SB	GC	FINISH: CP0024
21908	4	CABINET - FILLER PANEL - VARIABLE LENGTH	SB	GC	FINISH: CP0024; LENGTH REQUIRED: (1) 0' - 3 1/4" (1) 0' - 2" (1) 0' - 3"
21909	1	CABINET - DT POS UPPER CUBBY - 32IN 815MM	SB	GC	FINISH: PL0019
21910	1	CABINET - FRENCH CLEAT - VARIABLE LENGTH	SB	GC	OVERALL LENGTH REQUIRED: 2' - 6 1/2"
21912	1	CABINET - BACK PANEL FOR POS - 30IN 760MM	SB	GC	
21913	3	CABINET - EQUIPMENT MOUNTING PANEL	SB	GC	
22632	1	CABINET - CBE DRY INCLUSION SHELF - 44IN 1120MM - FLAT BLACK MT0028	SB	GC	PROVIDED BY CASEWORK VENDOR
22749	1	CABINET - ESPRESSO PUMP MOUNT PANEL	SB	GC	
22980	2	CABINET - ADJUSTABLE SHELF - 21IN 535MM	SB	GC	
22981	1	CABINET - BACK PANEL FOR POS - 21IN 535MM	SB	GC	
22982	1	CABINET - BOTTOM SHELF - 21IN 535MM	SB	GC	
X5006	2	CUSTOM CABINET - BACKBAR - 37.5IN 950MM	SB	GC	FINISH: PL0019; SEE DETAIL: 5/I-508; PROVIDED BY CASEWORK VENDOR
X5013	1	CUSTOM CABINET - BACKBAR COUNTER SUPPORT PANEL - 3IN 75MM	SB	GC	FINISH: PL0019; SEE DETAIL: 3/I-508; SIMILAR TO DID #17573; CUSTOM DUE TO DEPTH; PROVIDED BY CASEWORK VENDOR
<b>COUNTERTOP</b>					
21919	5	COUNTERTOP - FILLER BACKBAR - VARIABLE LENGTH	SB	GC	FINISH: CP0030; LENGTH REQUIRED: (2) 0' - 0 3/4" (2) 0' - 2 1/4" (1) 0' - 0 1/2"
21925	3	COUNTERTOP - BACKBAR - 15IN 380MM	SB	GC	FINISH: CP0030
21927	2	COUNTERTOP - BACKBAR - 30IN 760MM	SB	GC	FINISH: CP0030
21928	3	COUNTERTOP - END CAP BACKBAR	SB	GC	FINISH: CP0030
22331	1	COUNTERTOP - BREW - RF - 105IN 2665MM	SB	GC	FINISH: CP0030
22356	1	COUNTERTOP - ESPRESSO BACKBAR - RF - 141IN 3580MM	SB	GC	FINISH: CP0030
22362	1	COUNTERTOP - DT POS - LF - 76IN 1930MM	SB	GC	FINISH: CP0030
22386	1	COUNTERTOP - WARMING WITH RACK - LF - 125IN 3175MM	SB	GC	FINISH: CP0030
22395	1	COUNTERTOP - HAND SINK LOW SPLASH - 15IN 380MM	SB	GC	
22635	1	COUNTERTOP - CBE - LF - 152IN 3860MM	SB	GC	FINISH: CP0030
X5001	1	CUSTOM COUNTERTOP - ESPRESSO BACKBAR - LF - 47.75IN 1215MM	SB	GC	FINISH: CP0030; SEE DETAIL: 1/I-508; PROVIDED BY CASEWORK VENDOR
X5002	1	CUSTOM COUNTERTOP - ADD PARTNER - 81.5IN 2070MM	SB	GC	FINISH: CP0030; SEE DETAIL: 2/I-508; PROVIDED BY CASEWORK VENDOR
X5003	10	CUSTOM COUNTERTOP - 2FT BACKSPLASH - VARIABLE LENGTH	SB	GC	FINISH: CP0030; SEE DETAIL: 9/I-507; PROVIDED BY CASEWORK VENDOR LENGTH REQUIRED: (1) 14' - 0 1/8" (1) 4' - 1" (1) 0' - 0 3/4" (1) 1' - 10 1/4" (1) 2' - 7 1/2" (1) 0' - 6 3/4" (1) 3' - 4 1/4" (1) 13' - 0" (1) 17' - 2 3/4" (1) 15' - 8"
X5004	3	CUSTOM COUNTERTOP - 2FT 5IN BACKSPLASH - VARIABLE LENGTH	SB	GC	FINISH: CP0030; PROVIDED BY CASEWORK VENDOR LENGTH REQUIRED: (2) 2' - 6 1/2" (1) 6' - 9 1/2"
X5005	1	CUSTOM COUNTERTOP - DT AREA BACKBAR - 79.5IN 2020MM	SB	GC	FINISH: CP0030; SEE DETAIL: 3/I-508; PROVIDED BY CASEWORK VENDOR
X5010	1	CUSTOM COUNTERTOP - 2FT BACKSPLASH - VARIABLE LENGTH	SB	GC	FINISH: CP0030; PROVIDED BY CASEWORK VENDOR LENGTH REQUIRED: (1) 1' - 3"
X5011	3	CUSTOM COUNTERTOP - 2FT BACKSPLASH - VARIABLE LENGTH	SB	GC	FINISH: CP0056; SEE DETAIL: 5/I-511; PROVIDED BY CASEWORK VENDOR LENGTH REQUIRED: (1) 0' - 10" (1) 0' - 11" (1) 10' - 4"
X5015	1	CUSTOM COUNTERTOP - DT POS - RF - 45IN 1145MM	SB	GC	FINISH: CP0030; SEE DETAIL: 4/I-508; PROVIDED BY CASEWORK VENDOR
<b>DIEWALL</b>					
21885	15	DIEWALL - FRAMING - VARIABLE LENGTH	SB	GC	
21888	46	DIEWALL - SUPPORT LEG	SB	GC	
<b>OTHER</b>					
10829	11	CORNER GUARD - 75IN 19MM	SB	GC	LOCATED @ BOH SST
11155	2	ESPRESSO MACHINE PUMP MOUNT - 10X10IN 25X255MM	SB	GC	
21914	8	FRIDGE STOP BRACKET SET	SB	GC	
X5007	2	CUSTOM WOOD SHELVES	SB	GC	FINISH: WD0077; SEE DETAIL: 1/I-509; PROVIDED BY CW VENDOR
X5008	1	CUSTOM DT SILL TOP	SB	GC	FINISH: CP0030; SEE DETAIL: 7/I-509; PROVIDED BY CASEWORK VENDOR
X5009	1	CUSTOM PICK UP WINDOW SILL TOP	SB	GC	FINISH: CP0030; SEE DETAIL: 4/I-509; PROVIDED BY CASEWORK VENDOR
X5012	1	CUSTOM PICK UP WINDOW SILL TOP	SB	GC	FINISH: CP0056; SEE DETAIL: 5/I-511; PROVIDED BY CASEWORK VENDOR
X5016	1	CUSTOM METAL FLAT BAR AT PARTNER'S AREA	SB	GC	FINISH: PAINTED TO MATCH SW7031-ES; SEE DETAIL: 6/A-502; PROVIDED BY CASEWORK VENDOR
X5017	1	CUSTOM METAL FLAT BAR AT WORKROOM	SB	GC	FINISH TO MATCH SW7031-ES; SEE DETAIL: 7/A-502; PROVIDED BY CASEWORK VENDOR
X5018	1	CUSTOM STAND-UP SHELF	SB	GC	FINISH: WD0077; SEE DETAIL: 4/I-512

CW FINISH - NCS			
LOCATION	DESCRIPTION	FINISH CODE	COMMENTS
<b>CABINETS</b>			
DT POS CUBBY	PLASTIC LAMINATE - MOTTLED BLACK	PL0019	
UNDERCOUNTER CABINET BACKBAR	COMPOSITE - BLACK DIAMOND PAPERSTONE	CP0024	
UNDERCOUNTER CABINET FRONTBAR	COMPOSITE - BLACK DIAMOND PAPERSTONE	CP0024	
UNDERCOUNTER CABINET INTERIOR	PLASTIC LAMINATE - BLACK	PL0044	
<b>COUNTERTOPS</b>			
ADD, CBE AND NITRO COUNTERTOPS	COMPOSITE - WHISPER	CP0030	
DT POS, BREW AND WARM COUNTERTOPS	COMPOSITE - WHISPER	CP0030	
ESPRESSO AND POS COUNTERTOPS	COMPOSITE - WHISPER	CP0030	
HAND SINK COUNTERTOP	STAINLESS STEEL - BRUSHED	#4 BRUSHED 16GA SST	
<b>OTHER</b>			
CUSTOM PICK-UP WINDOW SILL TOP & CORIAN PANEL	COMPOSITE - BRUSHED WARM GREY	CP0056	
SHROUD	COMPOSITE - WHISPER	CP0030	
WINDOW SILL TOP	COMPOSITE - WHISPER	CP0030	

**RESPONSIBILITY LEGEND**

FURN. BY	INST. BY
SB - FURNISHED BY STARBUCKS	GC - INSTALLED BY GENERAL CONTRACTOR
GC - FURNISHED BY GENERAL CONTRACTOR	SB - INSTALLED BY STARBUCKS
VD - FURNISHED BY VENDOR	VD - INSTALLED BY VENDOR

**NOTE:** ALL RESPONSIBILITIES TO BE CONFIRMED WITH STARBUCKS CONSTRUCTION MANAGER PRIOR TO ORDERING / CONSTRUCTION.

**REVIEWED FOR CODE COMPLIANCE**  
 Wayne Thorne - PX3005 11-09-23  
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STATE OF FLORIDA  
 DONALD J. RETHMAN  
 AR0017303  
 REGISTERED ARCHITECT  
 11/06/2023

**FOR CONSTRUCTION**

PROJECT NAME:  
**US 17-92 & LAKE MARY BLVD**

PROJECT ADDRESS:  
**3764 ORLANDO DRIVE  
 SANFORD, FL 23773**

STORE #:	81065
PROJECT #:	98504-001
ISSUE DATE:	08-03-2023
DESIGNER:	PAULINA LOPEZ
PRODUCTION DESIGNER:	ANDY MCLOUD
CHECKED BY:	DONALD RETHMAN

Revision Schedule			
Rev	Date	By	Description

SHEET TITLE:  
**CASEWORK SCHEDULES**

SCALE: NO SCALE

SHEET NUMBER:  
**I-103**

C:\Users\kallej.jennings\Documents\98504-001\_81065\_US 17-92 & Lake Mary Blvd., FL\_2021\_kallej.jennings.rvt 11/6/2023 1:18:47 PM


WALL BASE SCHEDULE - "B"						
DESIGN ID	LENGTH	DESCRIPTION	FURN. BY	INST. BY	COMMENTS	
<b>METAL BASE</b>						
X9101	11' - 11"	METAL BASE - 6IN 150MM - BLACK - MT0028	GC	GC	PROVIDED BY CASEWORK VENDOR	
<b>TILE BASE</b>						
19795	277' - 5 3/4"	POLYVINYL TILE BASE SHEET - ECO-GRIP - PEWTER - 6X96IN 150X2438MM	GC	GC		
X9102	27' - 6 1/2"	SCHLUTER BASE - DILEX - AHK ALUMINUM TRIM	GC	GC	SCHLUTER SYSTEM WILL REQUIRE USE OF 90 DEGREE CORNER PIECE TO ACCOMMODATE FOR RADIUS TRIM PROFILE.	

FLOOR TREATMENT SCHEDULE - "T"						
DESIGN ID	AREA	DESCRIPTION	FURN. BY	INST. BY	COMMENTS	
<b>TILE</b>						
19795	1117 SF	POLYVINYL FLOOR SHEET - ECO-GRIP - PEWTER - 60X96IN 1524X2438MM	GC	GC		
20228	59 SF	TILE - I COCCI - CEMENTO - 24X24IN 600X600MM	SB	GC	GROUT: MAPEI - 47 CHARCOAL, OR EQUAL	

**RESPONSIBILITY LEGEND**

FURN. BY	INST. BY
SB - FURNISHED BY STARBUCKS	GC - INSTALLED BY GENERAL CONTRACTOR
GC - FURNISHED BY GENERAL CONTRACTOR	SB - INSTALLED BY STARBUCKS
VD - FURNISHED BY VENDOR	VD - INSTALLED BY VENDOR

**NOTE:** ALL RESPONSIBILITIES TO BE CONFIRMED WITH STARBUCKS CONSTRUCTION MANAGER PRIOR TO ORDERING / CONSTRUCTION.

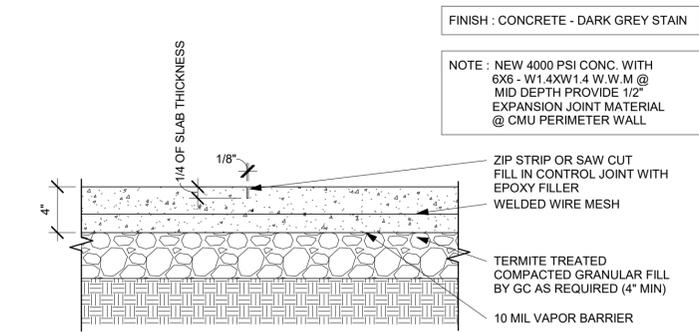

**2 TYPICAL CONCRETE SLAB @ CONTROL JOINT DETAIL**  
Scale: 1 1/2" = 1'-0"

**REVIEWED FOR CODE COMPLIANCE**  
Wahne Thorne - PX3005 11-09-23  
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**GENERAL NOTES**


- A. WORKROOM TO BE FINISHED PER LOCAL CODE REQUIREMENTS.
- B. FLOORS, WALLS AND CEILING FINISHES IN FOOD PREPARATION AREAS SHALL BE SMOOTH, NON-TOXIC, NON-ABSORBENT, DURABLE AND EASILY CLEANABLE. PAINT SHALL BE WASHABLE; SEMI-GLOSS OR HIGH-GLOSS FINISH.
- C. STARBUCKS TO SUPPLY FLOORING AND BASE FOR FRONT AND BACK OF HOUSE AS NOTED IN SCHEDULES. GENERAL CONTRACTOR TO INSTALL. GENERAL CONTRACTOR TO SUPPLY WORKROOM TILE AND BASE AND INSTALL. GENERAL CONTRACTOR TO SUPPLY AND INSTALL MORTAR, ADHESIVE, AND GROUT. GENERAL CONTRACTOR TO INSPECT ALL TILES AND REJECT DAMAGED OR SUBSTANDARD TILES PRIOR TO INSTALLATION.
- D. ALIGN TILE TRANSITIONS ON WHOLE TILES AS SHOWN.
- E. ALL FLOOR AND WALL JUNCTIONS IN STORAGE AND FOOD PREPARATION AREAS SHALL HAVE A 6" COVED BASE.

**KEYED NOTES**

- 1. INSTALL FLOOR TILE AT PARTNER'S RESTROOM AS INDICATED.
- 2. FLOOR SINK/ DRAIN LOCATION. SEE BUILDING FLOOR PENETRATION PLAN ON SHEET A-102 AND PLUMBING FOR ADDITIONAL INFORMATION.
- 3. INSTALL POLYVINYL SHEET FLOORING AND BASE AT ENGINE AREA, WORKROOM, PARTNER'S AREA AND MANAGER'S AREA AS INDICATED.
- 4. POLYVINYL TILE START POINT WHERE INDICATED.
- 5. INSTALL SCHLUTER BASE AT RESTROOM AS INDICATED.
- 6. INSTALL METAL BASE AT EXTERIOR DT WINDOW AS INDICATED.

**LEGEND**

	POLYVINYL SHEET FLOORING - ECO-GRIP - PEWTER - 60X96IN 1524X2438MM	T 19795
	TILE - I COCCI - CEMENTO - 24X24IN 600X600MM	T 20228
	POLYVINYL TILE BASE - ECO-GRIP - PEWTER - 6X96IN 150X2438MM	B 19795
	METAL BASE - 6IN 150MM - BLACK - MT0028	B X9101
	SCHLUTER BASE - DILEX - AHK TRIM	B X9102
	DATUM POINT	

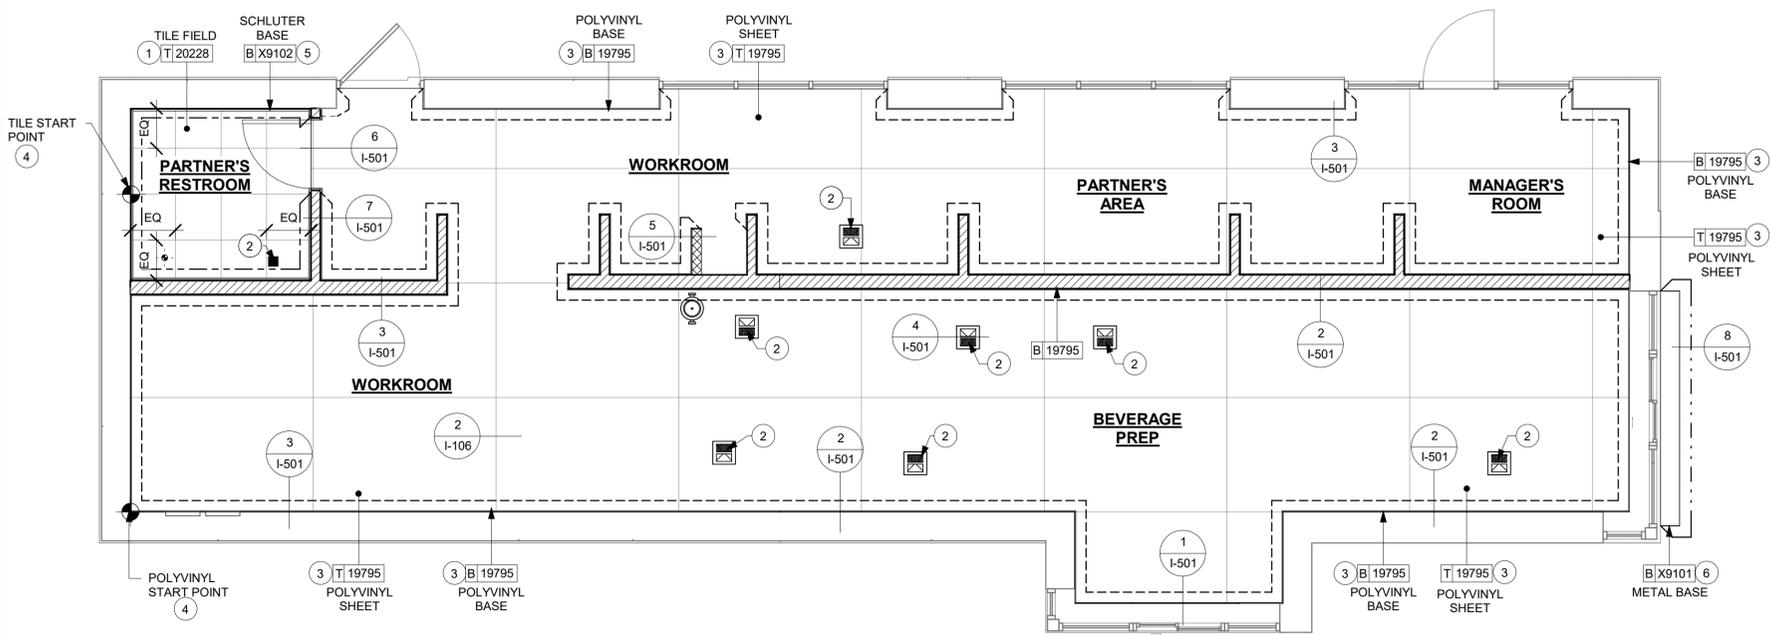

**1 FLOOR FINISH PLAN**  
Scale: 1/4" = 1'-0"



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Tel: (844) 804-7700  
Timothy L. Raberding, PE  
Professional Engineer  
License: 62078



**FOR CONSTRUCTION**

PROJECT NAME:  
**US 17-92 & LAKE MARY BLVD**

PROJECT ADDRESS:  
**3764 ORLANDO DRIVE  
SANFORD, FL 23773**

STORE #: 81065  
PROJECT #: 98504-001  
ISSUE DATE: 08-03-2023  
DESIGNER: PAULINA LOPEZ  
PRODUCTION DESIGNER: ANDY MCLLOUD  
CHECKED BY: DONALD RETHMAN

Revision Schedule			
Rev	Date	By	Description

SHEET TITLE:  
**FLOOR FINISH PLAN**

SCALE: As indicated

SHEET NUMBER:  
**I-106**

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PAINT SCHEDULE						
COLOR CODE	DESCRIPTION	LRV	FURN. BY	INST. BY	COMMENTS	
SW6991-SG	SW - BLACK MAGIC - SEMIGLOSS	6	GC	GC	USE PRIMER CP-1	
SW7031-ES	SW - MEGA GREIGE - EGG SHELL	37	GC	GC	USE PRIMER CP-1	
SW7033-ES	SW - BRAINSTORM BRONZE - EGG SHELL	15	GC	GC	USE PRIMER CP-1	
SW7033-SG	SW - BRAINSTORM BRONZE - SEMIGLOSS	15	GC	GC	USE PRIMER CP-1	
SW7631-ES	SW - CITY LOFT - EGG SHELL	70	GC	GC	USE PRIMER CP-1	

WALL TREATMENT (AREA) SCHEDULE - "Q"						
DESIGN ID	AREA	DESCRIPTION	FURN. BY	INST. BY	COMMENTS	
PLASTIC						
11469	1649 SF	FRP - WHITE	GC	GC		
TILE						
20227	241 SF	TILE - I COCCI - CEMENTO - 6X24IN 150X600MM	SB	GC	GROUT: MAPEI - 47 CHARCOAL, OR EQUAL	
X9202	480 SF	TILE - GEO - BEIGE - MATTE - 3X10IN 75X255MM	SB	GC	GROUT MAPEI 106 WALNUT-3/16"; VD: FIVE STAR CERAMICS GROUP; CONTACT INFO: CHRISM@FIVESC.COM	
WALLCOVERING						
17854	113 SF	VINYL WALL COVERING - TADAO - STARBUCKS WG11184374	SB	GC		

WALL TREATMENT (LENGTH) SCHEDULE - "R"						
DESIGN ID	LENGTH	DESCRIPTION	FURN. BY	INST. BY	COMMENTS	
TRIM						
X9201	56' - 9 1/2"	QUADEC SCHLUTER JOLLY TRIM; 6MM - FINISH: CREAM	GC	GC	LOCATION: BACKBAR TILE CORNER; SEE DETAIL: 8&9/I-502; GC TO VERIFY LENGTHS	

**LEGEND**

- 1 --- INDICATES PARTIAL HEIGHT - FRP\* Q 11469
- 2 --- INDICATES BACKBAR WALL TILE\* Q X9202
- 3 --- INDICATES FULL HEIGHT FRP - WHITE\* Q 11469
- 4 --- INDICATES RESTROOM WALL TILE\*\* Q 20227
- 5 --- INDICATES WALLCOVERING\* Q 17854
- ┌┐ SCHLUTER TRIM - QUADEC R X9201
- └└ INDICATES HOT ROLLED STEEL CORNER GUARD FOR BOH. INSTALL 6" (150mm) TO 42" (1065mm) A.F.F. UNLESS OTHERWISE NOTED. C 10829
- \* SEE INTERIOR FINISH ELEVATIONS FOR TAGGED LOCATION OF WALL FINISH MATERIAL.
- \*\* SEE RESTROOM PLAN & ELEVATIONS FOR TAGGED LOCATION OF WALL FINISH MATERIAL.

**RESPONSIBILITY LEGEND**

FURN. BY	INST. BY
SB - FURNISHED BY STARBUCKS	GC - INSTALLED BY GENERAL CONTRACTOR
GC - FURNISHED BY GENERAL CONTRACTOR	SB - INSTALLED BY STARBUCKS
VD - FURNISHED BY VENDOR	VD - INSTALLED BY VENDOR

**NOTE:** ALL RESPONSIBILITIES TO BE CONFIRMED WITH STARBUCKS CONSTRUCTION MANAGER PRIOR TO ORDERING / CONSTRUCTION.

**REVIEWED FOR CODE COMPLIANCE**  
 Wayne Thorne - PX3005 11-09-23  
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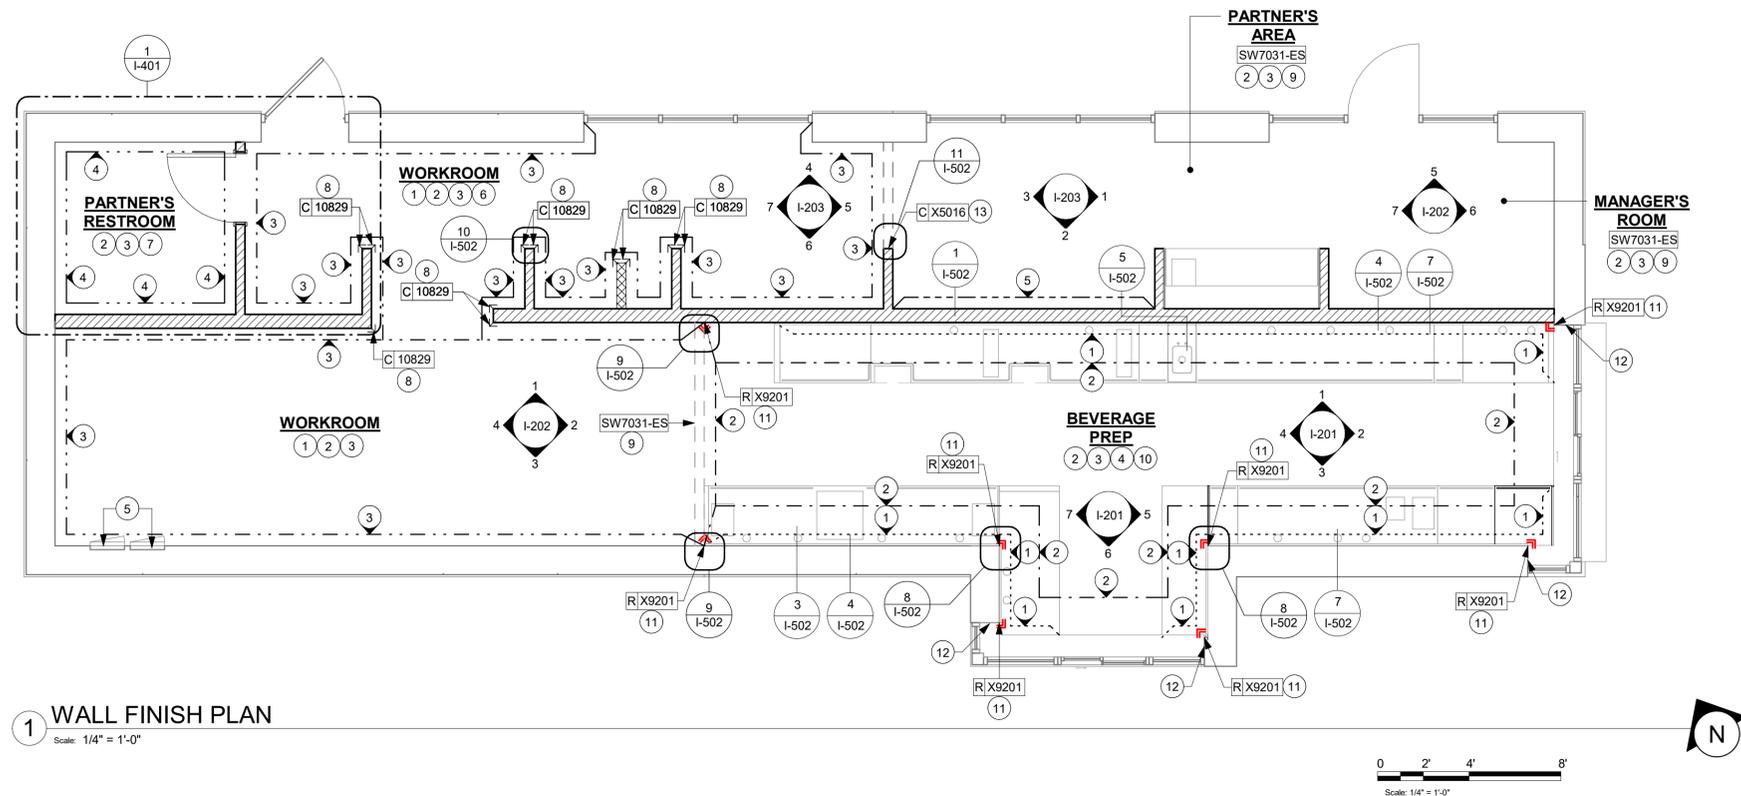
**BUILDING DEPARTMENT**  
**SANFORD**

**GENERAL NOTES**

- A. WORKROOM TO BE FINISHED PER LOCAL CODE REQUIREMENTS.
- B. GENERAL CONTRACTOR TO PROVIDE AND INSTALL WORKROOM WALL FINISHES.
- C. FLOORS, WALLS AND CEILING FINISHES IN FOOD PREPARATION AREAS SHALL BE SMOOTH, NON-TOXIC, NON-ABSORBENT, DURABLE AND EASILY CLEANABLE. PAINT SHALL BE WASHABLE, SEMI-GLOSS OR HIGH-GLOSS FINISH.
- D. CHANGE PAINT COLOR ONLY AT INSIDE CORNERS UNLESS OTHERWISE INDICATED.
- E. PAINT SUBSTITUTIONS ARE NOT ALLOWED. USE STARBUCKS' NATIONAL ACCOUNT "COLOR CODE" WHEN ORDERING PAINTS.
- F. PAINT FINISHES SHALL BE APPLIED AS FOLLOWS, UNLESS NOTED OTHERWISE:
  - a. WOODS AND METAL SURFACES SHALL BE SEMI-GLOSS OR EQUAL.
  - b. ACCENT AND TRIM PAINTS TO BE SEMI-GLOSS OR EQUAL. WALL AND CEILING PAINTS TO BE EGG SHELL OR EQUAL.
  - c. PAINTS IN BOH, RESTROOM(S) OR CAFE BAR SHALL BE SEMI-GLOSS OR EQUAL.
- G. ALL WOOD SURFACES (DOORS, TRIM, SHELVES, CABINERY) SHALL BE SEALED.
- H. REFER TO CASEWORK FINISH SCHEDULE FOR CASEWORK FINISH MATERIAL INFORMATION.
- I. REFER TO INTERIOR FINISH ELEVATIONS FOR ARTWORK/ GRAPHICS LOCATIONS.
- J. REFER TO MANUFACTURER'S INSTRUCTIONS INCLUDED WITH ARTWORK/GRAPHICS FOR PROPER INSTALLATION.
- K. ALL FLOOR AND WALL JUNCTIONS IN STORAGE AND FOOD PREPARATION AREAS SHALL HAVE A 6" COVED BASE.
- L. INSTALL BLOCKING AND HANGERS FOR WALL SHELVING BEFORE INSTALLING BACK BAR TILE.

**KEYED NOTES**

- 1. INSTALL FULL HEIGHT FRP AT WORKROOM WALLS AS INDICATED.
- 2. PROVIDE FIRE TREATED BLOCKING AS REQUIRED TO SUPPORT WALL ATTACHMENTS (SEE BUILDING FLOOR PLAN ON SHEET A-101 FOR MORE INFORMATION).
- 3. REFER TO SHEET I-502 FOR WALL FINISH DETAILS.
- 4. FRP BENEATH ENGINE AREA AT EXPOSED WALLS EXTEND FROM TOP OF WALL BASE TO UNDERSIDE OF COUNTERTOP.
- 5. EXISTING RECESSED ELECTRICAL PANELS.
- 6. MOP SINK. FULL HEIGHT FRP AT ENCLOSURE (SEE PLUMBING PLANS FOR MORE INFORMATION).
- 7. INSTALL WALL TILE AT RESTROOMS AS INDICATED.
- 8. INSTALL CORNER GUARD AT OUTSIDE CORNER AS INDICATED. SEE DETAILS: 10/I-502.
- 9. PAINT WALL AS INDICATED ON INTERIOR FINISH ELEVATIONS.
- 10. GC TO INSTALL BACKBAR WALL TILE AS INDICATED ON INTERIOR FINISH ELEVATIONS.
- 11. INSTALL QUADEC SCHLUTER TRIM AT TILE TO TILE OUTSIDE CORNER AS INDICATED. SEE DETAIL: 8&9/I-502.
- 12. BACKBAR TILE TO RETURN TO MULLIONS WITHIN DRIVE-THRU WINDOW OPENING AS INDICATED.
- 13. INSTALL METAL FLAT BAR AT PARTNER AREA HEADER AS INDICATED.



**1 WALL FINISH PLAN**  
 Scale: 1/4" = 1'-0"

**FOR CONSTRUCTION**



**STARBUCKS**  
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 (206) 318-1575

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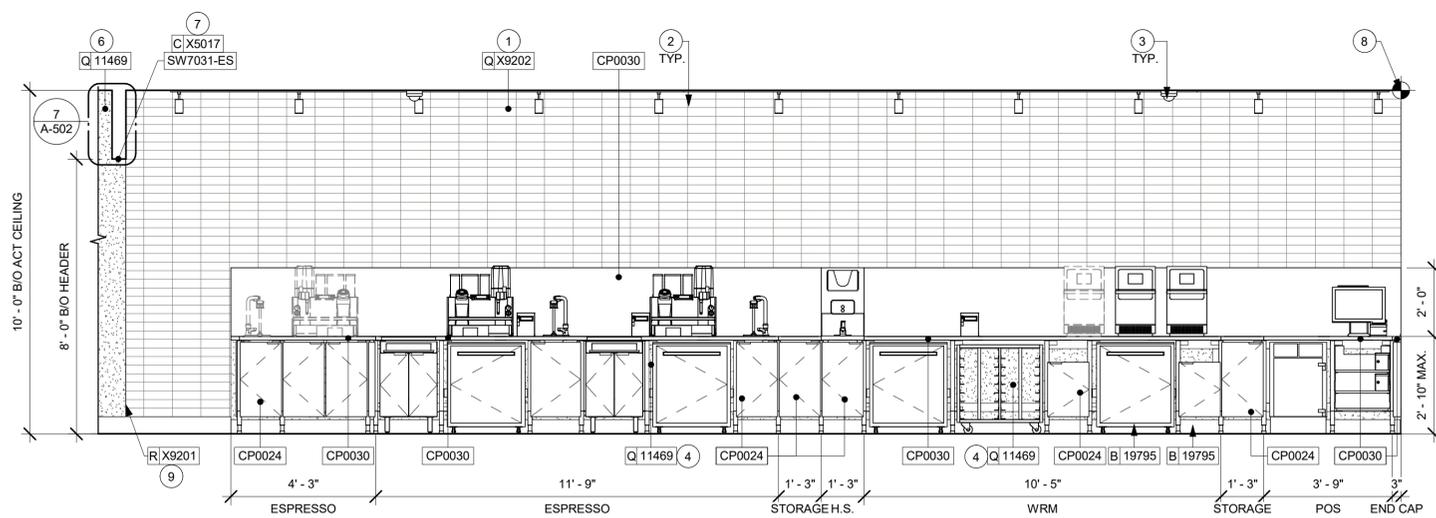
Revision Schedule			
Rev	Date	By	Description

SHEET TITLE:  
**WALL FINISH PLAN**

SCALE: 1/4" = 1'-0"


SHEET NUMBER:  
**I-107**

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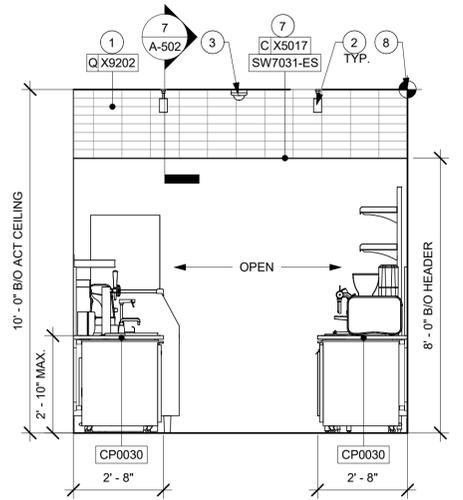
**1 BACKBAR - WRM**

Scale: 3/8" = 1'-0"




**2 WALK OFF WINDOW**

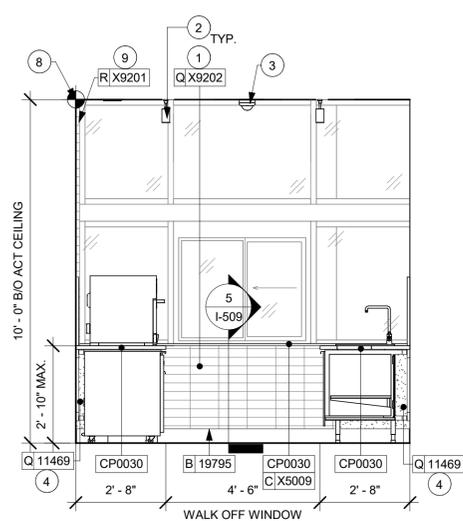Scale: 3/8" = 1'-0"




**4 BACKBAR - NORTHWEST**

Scale: 3/8" = 1'-0"

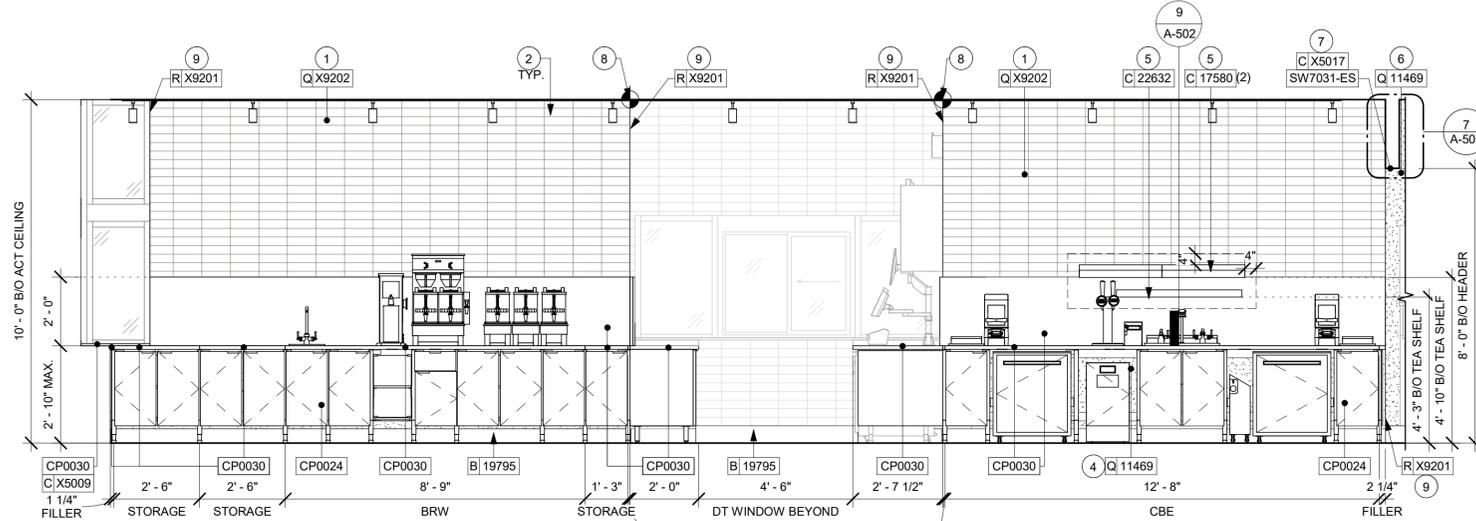


**3 BACKBAR**

Scale: 3/8" = 1'-0"

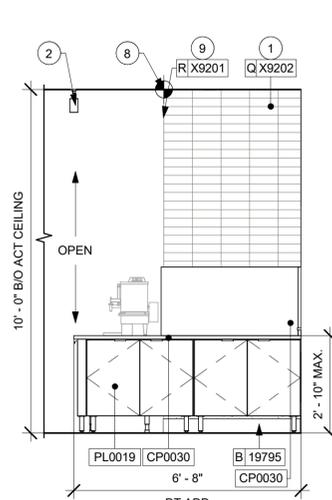


**5 DT ADD**

Scale: 3/8" = 1'-0"

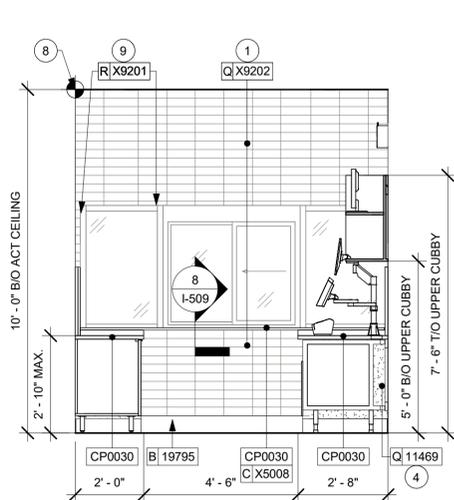

**6 DT WINDOW**

Scale: 3/8" = 1'-0"

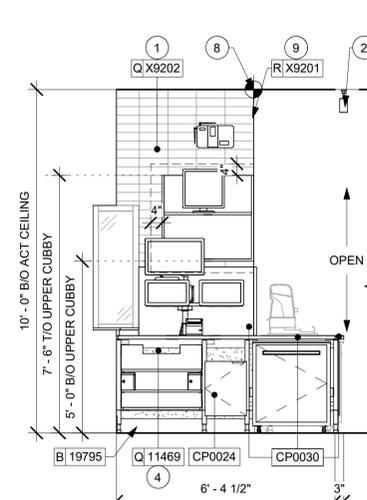

**7 DT POS**

Scale: 3/8" = 1'-0"



**REVIEWED FOR CODE COMPLIANCE**  
 Wayne Thorne - PX3005 11-09-23  
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**BUILDING DEPARTMENT**  
**SANFORD**



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**FOR CONSTRUCTION**

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PROJECT ADDRESS:  
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 SANFORD, FL 23773**


STORE #: 81065  
 PROJECT #: 98504-001  
 ISSUE DATE: 08-03-2023  
 DESIGNER: PAULINA LOPEZ  
 PRODUCTION DESIGNER: ANDY MCLLOUD  
 CHECKED BY: DONALD RETHMAN

Revision Schedule			
Rev	Date	By	Description


SHEET TITLE:  
**INTERIOR FINISH ELEVATIONS**  
 SCALE: 3/8" = 1'-0"

SHEET NUMBER:  
**I-201**


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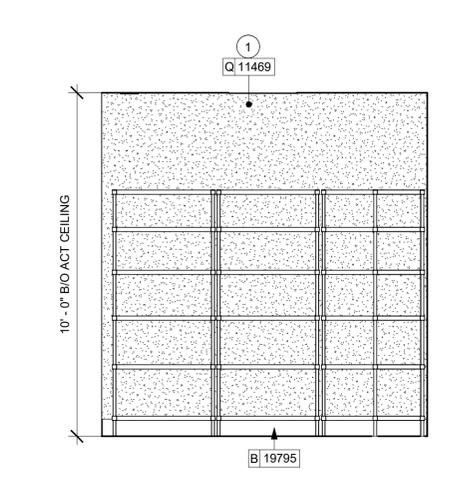
**1 HAND SINK**  
Scale: 3/8" = 1'-0"

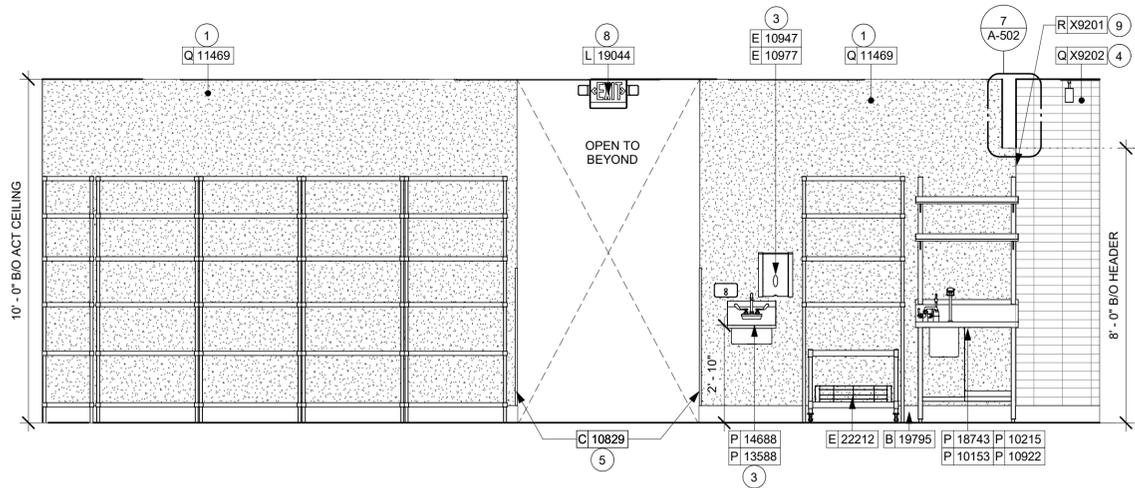


**2 WORKROOM - SOUTHEAST**  
Scale: 3/8" = 1'-0"

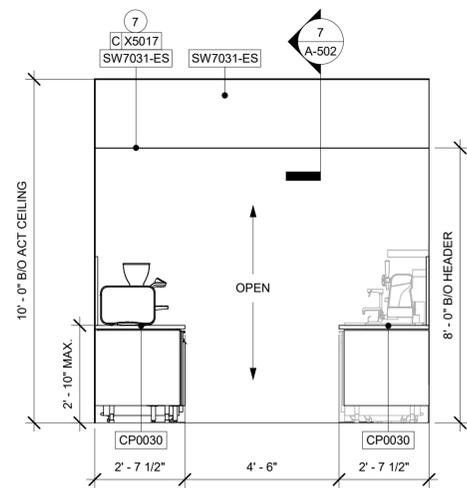


**3 ICE - MACHINE**  
Scale: 3/8" = 1'-0"

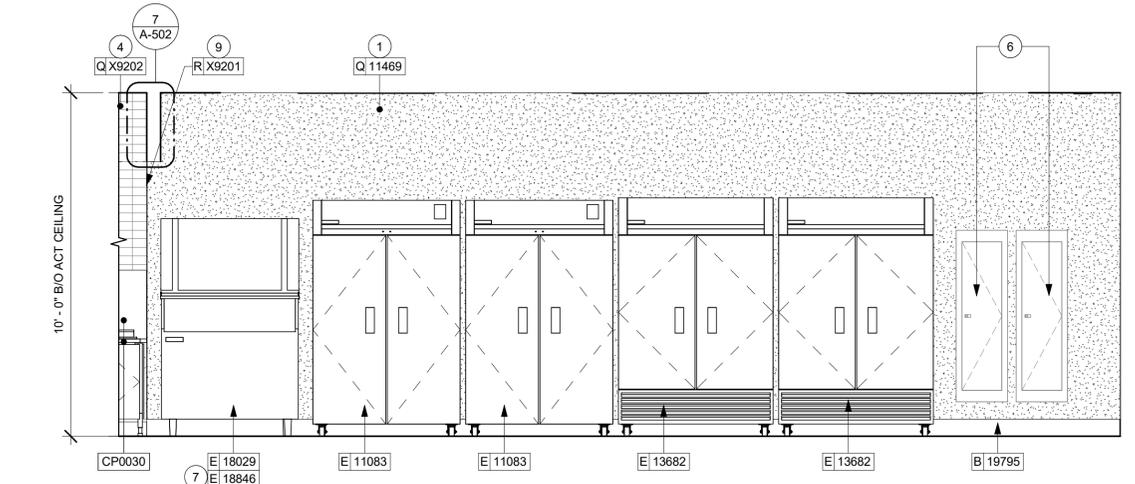


**4 SHELVING**  
Scale: 3/8" = 1'-0"

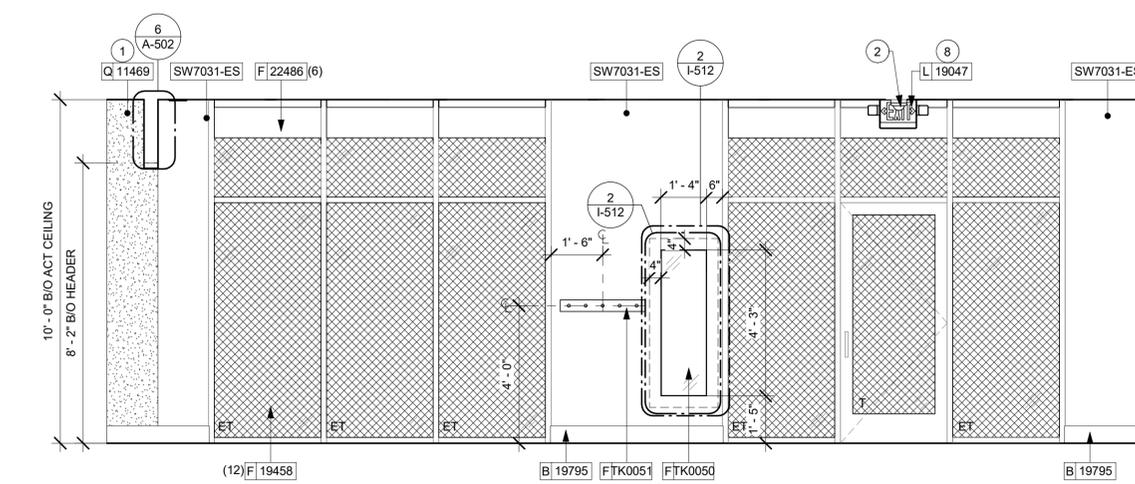

**5 COAT HOOK**  
Scale: 3/8" = 1'-0"

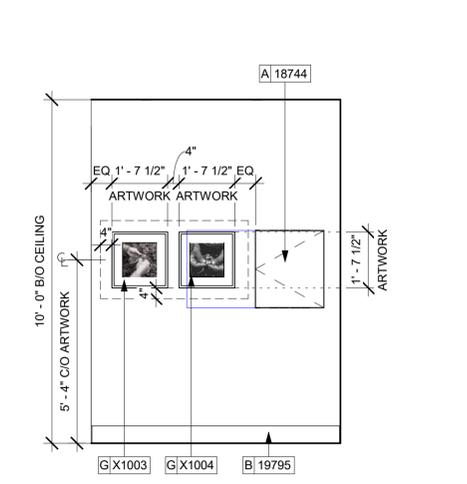

**6 MANAGER'S ROOM - SOUTHEAST**  
Scale: 3/8" = 1'-0"

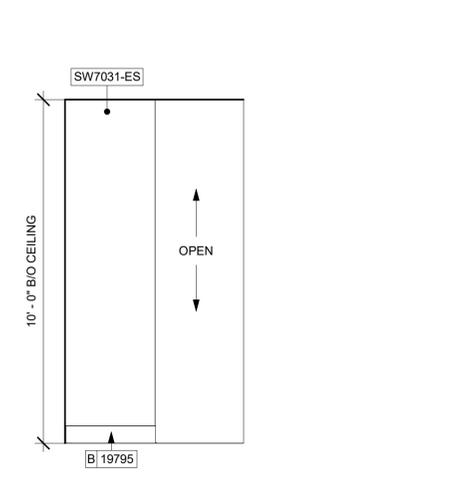

**7 MANAGER'S ROOM - NORTHWEST**  
Scale: 3/8" = 1'-0"



**REVIEWED FOR CODE COMPLIANCE**  
Wagne Thorne - PX3005 11-09-23  
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Timothy L. Raberding, PE  
Professional Engineer  
License: 62079



**GENERAL NOTES**

- A. FOR PAINT AND WALL TREATMENT SCHEDULES, REFER TO THE INTERIOR FINISH SHEET. FOR GRAPHICS SCHEDULE, REFER TO THE FURNITURE, FIXTURES, AND EQUIPMENT (FF & E) SCHEDULES.
- B. REFER TO MANUFACTURER'S INSTRUCTIONS INCLUDED WITH ARTWORK/GRAPHICS FOR PROPER INSTALLATION.
- C. PAINT FINISHES SHALL BE APPLIED AS FOLLOWS, UNLESS NOTED OTHERWISE:
  1. WOODS AND METAL SURFACES SHALL BE SEMI-GLOSS OR EQUAL.
  2. ACCENT AND TRIM PAINTS TO BE SEMI-GLOSS OR EQUAL. WALL AND CEILING PAINTS TO BE EGGSHELL OR EQUAL.
  3. PAINTS IN BOH, RESTROOM(S) OR CAFE BAR SHALL BE SEMI-GLOSS OR EQUAL.
- D. FLOORS, WALLS AND CEILING FINISHES IN FOOD PREPARATION AREAS SHALL BE SMOOTH, NON-TOXIC, NON-ABSORBENT, DURABLE AND EASILY CLEANABLE. PAINT SHALL BE WASHABLE; SEMI-GLOSS OR HIGH GLOSS FINISH.

**KEYED NOTES**

1. INSTALL FULL HEIGHT FRP AT WORKROOM WALL AS INDICATED.
2. INSTALL CEILING MOUNTED SECURITY CAMERA AS INDICATED.
3. WALL MOUNT HAND SINK WITH SOAP AND PAPER TOWEL DISPENSER. GC TO PROVIDE BLOCKING FOR FASTENERS. SEE DETAIL ON SHEET 6/I-502.
4. GC TO INSTALL BACKBAR WALL TILE AS INDICATED. SEE DETAIL ON SHEET 6/I-502.
5. INSTALL CORNER GUARD AT OUTSIDE CORNER AS INDICATED. SEE DETAILS: 10/I-502.
6. RECESSED ELECTRICAL PANELS (SEE ELECTRICAL DRAWINGS FOR ADDITIONAL INFORMATION).
7. ICE MACHINE (SEE PLUMBING AND ELECTRICAL DRAWINGS FOR ADDITIONAL INFORMATION).
8. LOCATION OF ALL EXIT/ EMERGENCY LIGHTS FOR REFERENCE ONLY. GC TO VERIFY WITH LOCAL FIRE MARSHAL PRIOR TO INSTALLATION.
9. INSTALL QUADEC SCHLUTER TRIM AT TILE TO TILE OUTSIDE CORNER AS INDICATED. SEE DETAIL: 8&9/I-502.

**LEGEND**

- INDICATES WALL BLOCKING. BLOCKING TO BE PROVIDED AS REQUIRED TO SUPPORT WALL ATTACHMENTS. EXTEND BLOCKING 4" (100mm) BEYOND EDGE OF ATTACHMENTS.
- WALL TILE START POINT DATUM

**FOR CONSTRUCTION**

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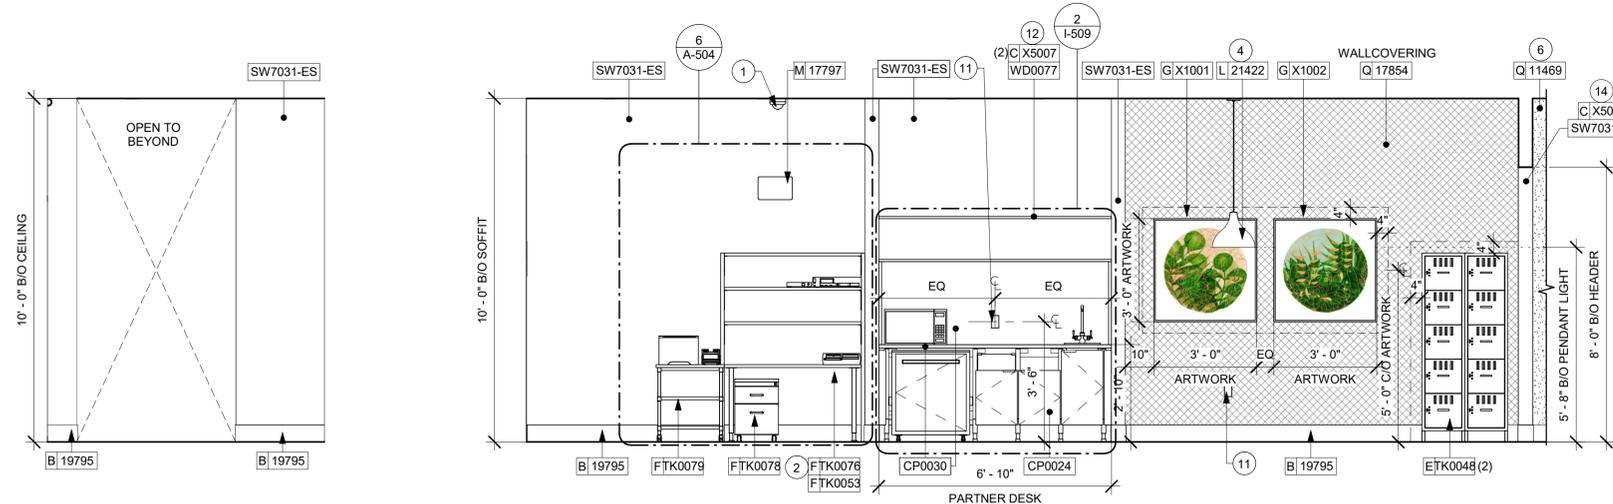
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PRODUCTION DESIGNER: ANDY MCLLOUD  
CHECKED BY: DONALD RETHMAN

Revision Schedule			
Rev	Date	By	Description

SHEET TITLE:  
**INTERIOR FINISH ELEVATIONS**  
SCALE: 3/8" = 1'-0"


SHEET NUMBER:  
**I-202**

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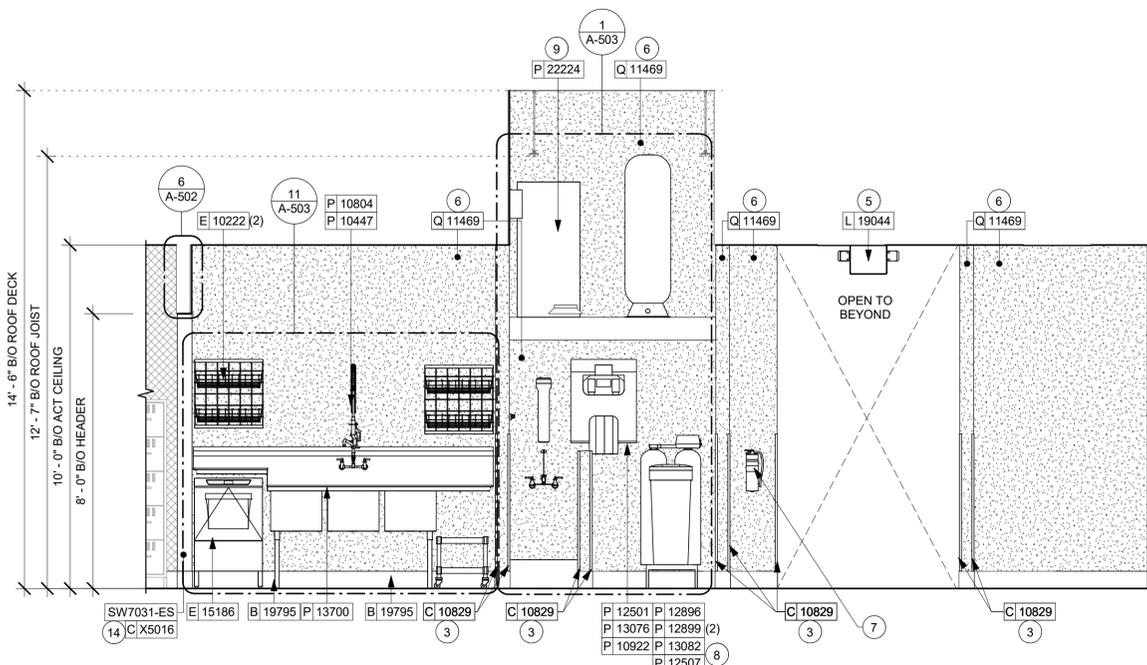
1 PARTNER'S ROOM - SOUTHEAST  
Scale: 3/8" = 1'-0"

2 MANAGER'S DESK  
Scale: 3/8" = 1'-0"




4 WORKROOM - NORTHEAST  
Scale: 3/8" = 1'-0"

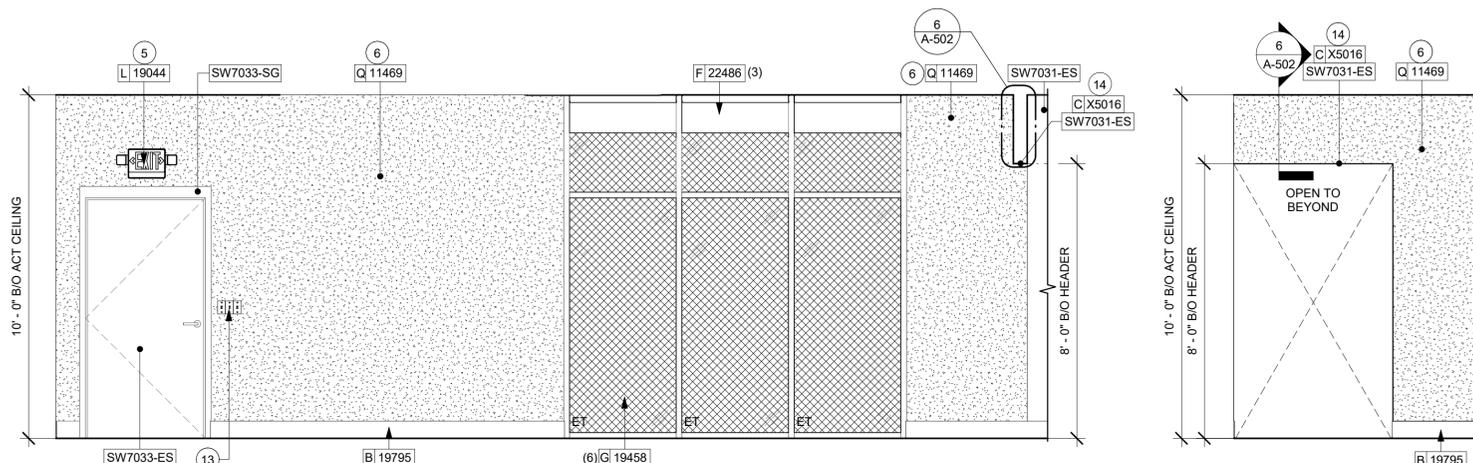5 PARTNER'S ROOM ENTRANCE  
Scale: 3/8" = 1'-0"



6 WATER FILTRATION SYSTEM  
Scale: 3/8" = 1'-0"

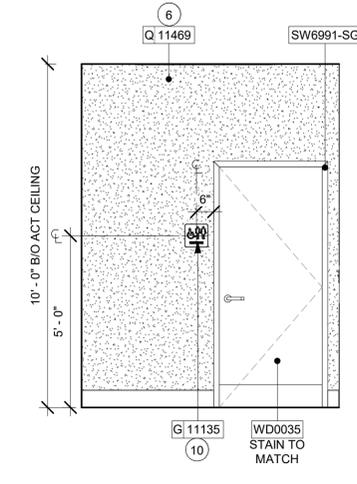

7 WORKROOM - NORTHWEST  
Scale: 3/8" = 1'-0"



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Wm Thorne - PX3005 11-09-23  
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DESIGNER: PAULINA LOPEZ  
PRODUCTION DESIGNER: ANDY MCLLOUD  
CHECKED BY: DONALD RETHMAN

Revision Schedule			
Rev	Date	By	Description

SHEET TITLE:  
**INTERIOR FINISH ELEVATIONS**  
SCALE: 3/8" = 1'-0"

SHEET NUMBER:  
**I-203**

C:\Users\kailey.jennings\Documents\98504-001\_81065\_US 17-92 & Lake Mary Blvd, FL\_2021\_kailey.jennings.rvt 11/6/2023 1:19:12 PM



1 VIEW TOWARDS DT WINDOW

NOTE: 3D VIEWS ARE FOR REFERENCE ONLY. REFER TO DETAIL SHEETS FOR CONSTRUCTION.



3 VIEW TOWARDS WALK-UP WINDOW

NOTE: 3D VIEWS ARE FOR REFERENCE ONLY. REFER TO DETAIL SHEETS FOR CONSTRUCTION.



2 VIEW TOWARDS 3-COMP SINK

NOTE: 3D VIEWS ARE FOR REFERENCE ONLY. REFER TO DETAIL SHEETS FOR CONSTRUCTION.



4 VIEW TOPWARDS PARTNER'S SEATING

NOTE: 3D VIEWS ARE FOR REFERENCE ONLY. REFER TO DETAIL SHEETS FOR CONSTRUCTION.

REVIEWED FOR CODE COMPLIANCE  
 Wayne Thorne - PX3005 11-09-23  
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Timothy L. Roberding, PE  
 Professional Engineer  
 License: 62078



11/06/2023

FOR CONSTRUCTION

PROJECT NAME:  
**US 17-92 & LAKE MARY BLVD**

PROJECT ADDRESS:  
**3764 ORLANDO DRIVE  
 SANFORD, FL 23773**

STORE #: 81065  
 PROJECT #: 98504-001  
 ISSUE DATE: 08-03-2023  
 DESIGNER: PAULINA LOPEZ  
 PRODUCTION DESIGNER: ANDY MCLLOUD  
 CHECKED BY: DONALD RETHMAN


Revision Schedule			
Rev	Date	By	Description

SHEET TITLE:  
**PERSPECTIVE VIEW**


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SHEET NUMBER:  
**I-204**


C:\Users\kailey.jennings\Documents\98504-001\_81065\_US\_17-92 & Lake Mary Blvd., FL\_2021\_kailey.jennings.rvt 11/6/2023 1:19:14 PM

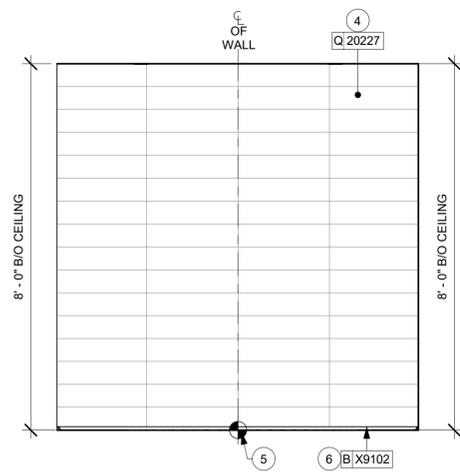


2 PARTNER'S RR - NORTHEAST  
Scale: 1/2" = 1'-0"

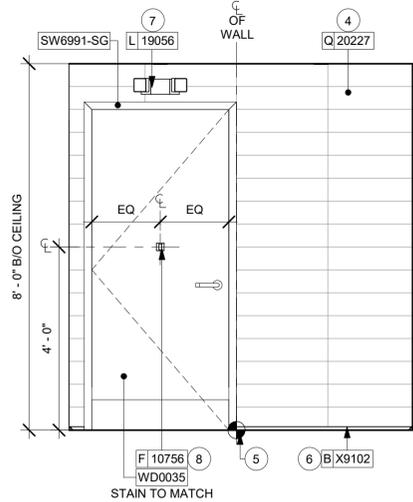



3 PARTNER'S RR - SOUTHEAST  
Scale: 1/2" = 1'-0"

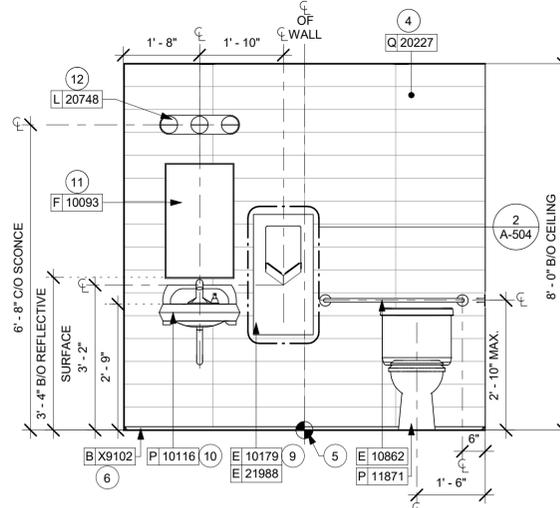


4 PARTNER'S RR - SOUTHWEST  
Scale: 1/2" = 1'-0"

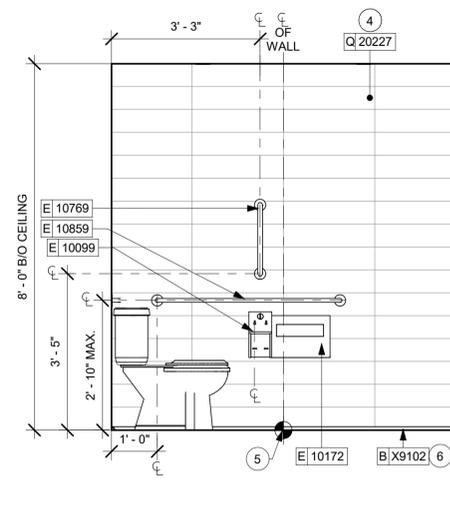


5 PARTNER'S RR - NORTHWEST  
Scale: 1/2" = 1'-0"

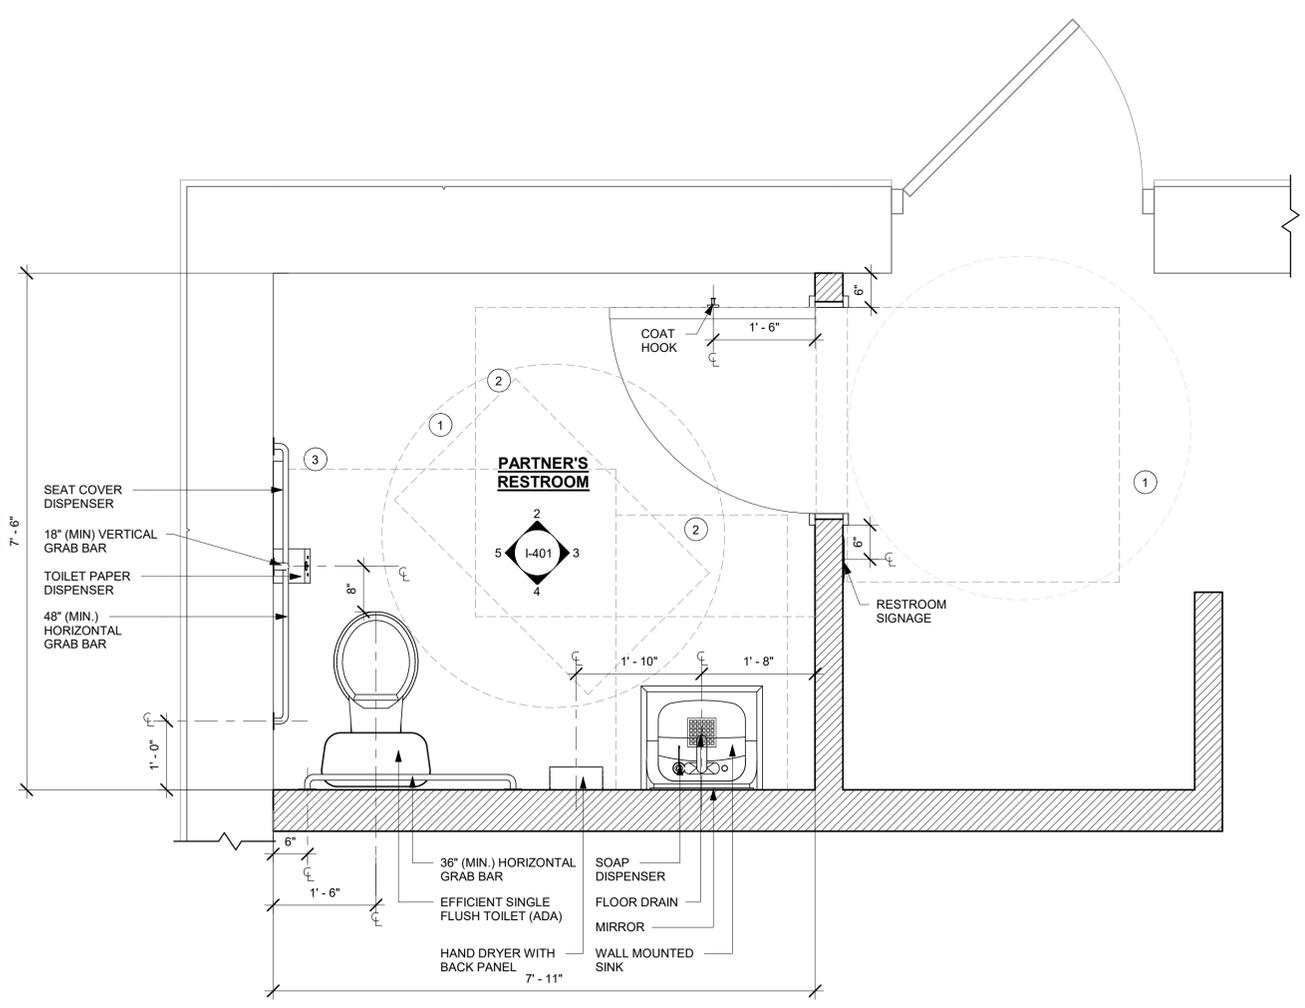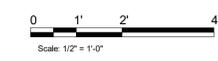

1 ENLARGED RESTROOM PLAN  
Scale: 3/4" = 1'-0"

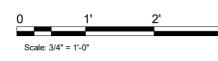

REVIEWED FOR CODE COMPLIANCE  
Wagne Thorne - PX3005 11-09-23  
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GENERAL NOTES

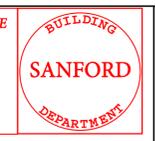- A. GENERAL CONTRACTOR TO VERIFY ALL DIMENSIONS AND NOTIFY STARBUCKS CONSTRUCTION MANAGER OF ANY DISCREPANCIES PRIOR TO CONSTRUCTION.
- B. ALL DIMENSIONS ARE TO BE TAKEN FROM A DESIGNATED DATUM POINT.
- C. DIMENSIONS ARE TO FACE OF FINISHED SURFACE UNLESS OTHERWISE NOTED.
- D. ALL RESTROOM ACCESSORY MOUNTING HEIGHTS AND CLEARANCES SHALL COMPLY WITH THE ACCESSIBILITY REQUIREMENTS OF THE LOCAL JURISDICTION.

KEYED NOTES

- 1. 60" (1524mm) ADA TURNING DIAMETER.
- 2. 30" (760mm) X 48" (1200MM) CLEAR FLOOR SPACE.
- 3. 60" (1524mm) X 56" (1422MM) WATER CLOSET CLEAR FLOOR SPACE.
- 4. INSTALL WALL TILE AT RESTROOMS AS INDICATED.
- 5. TILE START POINT WHERE INDICATED.
- 6. INSTALL METAL SCHLUTER DILEX AHK COVE BASE AS INDICATED.
- 7. INSTALL EMERGENCY LIGHT AS INDICATED.
- 8. INSTALL COAT HOOK. MOUNT AT CENTERLINE OF DOOR.
- 9. INSTALL HAND DRYER WITH BACK PANEL AS INDICATED.
- 10. WALL MOUNTED LAVATORY SINK INSTALLED WITH INSULATED BOOT AT EXPOSED PIPES.
- 11. CENTER MIRROR OVER LAVATORY SINK. MOUNT AT 40" (1015MM) MAX. TO BOTTOM EDGE OF REFLECTIVE SURFACE.
- 12. CENTER SCENCE LIGHTING OVER MIRROR.



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Timothy L. Raberding, PE  
Professional Engineer  
License: 62078



FOR CONSTRUCTION

PROJECT NAME:  
**US 17-92 & LAKE MARY BLVD**

PROJECT ADDRESS:  
**3764 ORLANDO DRIVE  
SANFORD, FL 23773**

STORE #: 81065  
PROJECT #: 98504-001  
ISSUE DATE: 08-03-2023  
DESIGNER: PAULINA LOPEZ  
PRODUCTION DESIGNER: ANDY MCLLOUD  
CHECKED BY: DONALD RETHMAN

Revision Schedule			
Rev	Date	By	Description

SHEET TITLE:  
**ENLARGED RESTROOM PLAN AND ELEVATIONS**  
SCALE: AS SHOWN

SHEET NUMBER:  
**I-401**

**REVIEWED FOR CODE COMPLIANCE**  
 Wayne Thorne - PX3005 11-09-23  
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**SANFORD**  
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PROJECT ADDRESS:  
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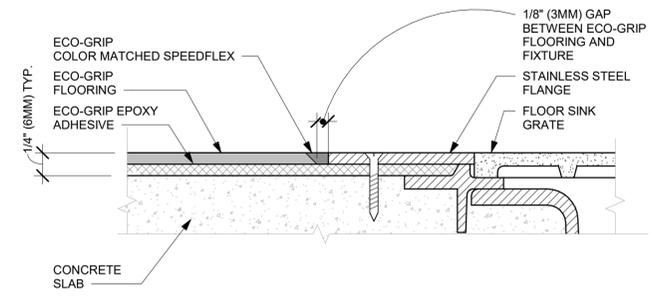
STORE #: 81065  
 PROJECT #: 98504-001  
 ISSUE DATE: 08-03-2023  
 DESIGNER: PAULINA LOPEZ  
 PRODUCTION DESIGNER: ANDY MCLLOUD  
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Revision Schedule			
Rev	Date	By	Description


SHEET TITLE:  
**FLOOR FINISH DETAILS**

SCALE: AS SHOWN


SHEET NUMBER:  
**I-501**




4 ECO-GRIP TO FLOOR SINK TRANSITION  
 Scale: 12" = 1'-0"

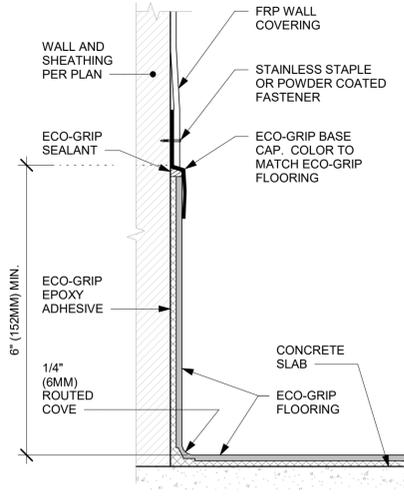


3 ECO-GRIP BASE CAP WITH FRP  
 Scale: 6" = 1'-0"

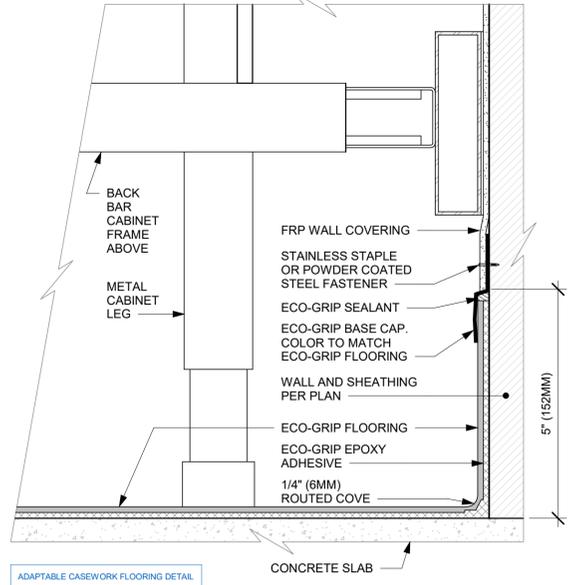


2 ECO-GRIP AC BACK BAR CABINET ON LEGS  
 Scale: 6" = 1'-0"

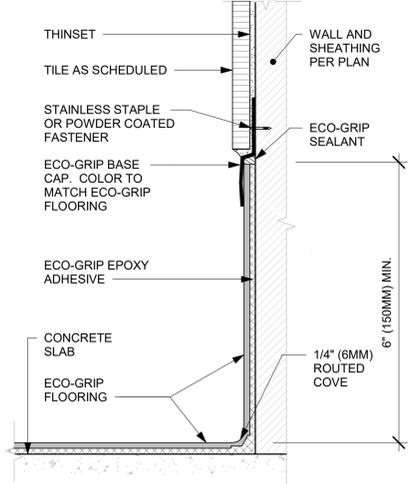


1 ECO-GRIP BASE CAP WITH TILED WALL  
 Scale: 6" = 1'-0"

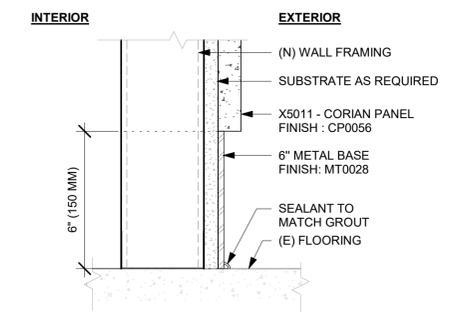


8 METAL BASE AT CORIAN PANEL  
 Scale: 3" = 1'-0"

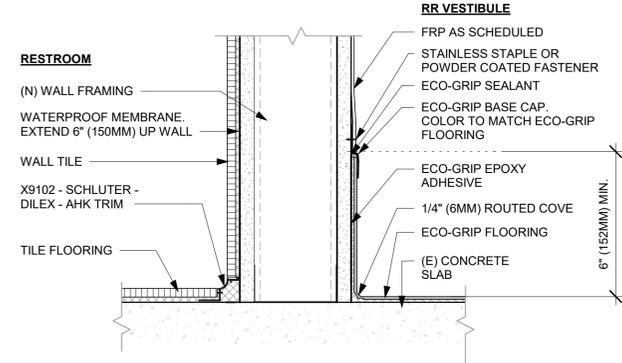

7 X9102 - SCHLUTER BASE AT RESTROOM WALL  
 Scale: 3" = 1'-0"

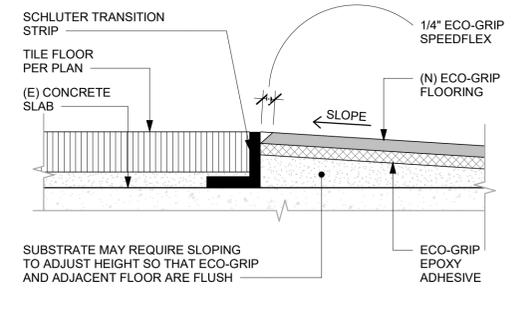


6 ECO-GRIP TO TILE TRANSITION  
 Scale: 12" = 1'-0"

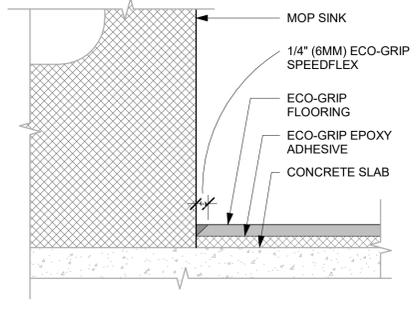


5 ECO-GRIP AT MOP SINK  
 Scale: 12" = 1'-0"


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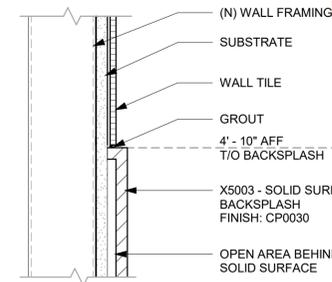
1 VINYL WALLCOVERING  
Scale: 3" = 1'-0"

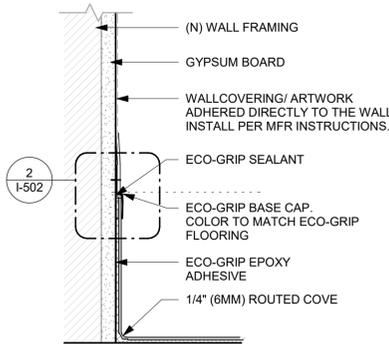

2 VINYL WALLCOVERING AT ECO GRIP BASE  
Scale: 6" = 1'-0"

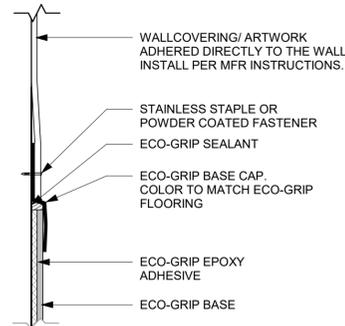


3 FRP AT BACKLINE CABINETS  
Scale: 1 1/2" = 1'-0"

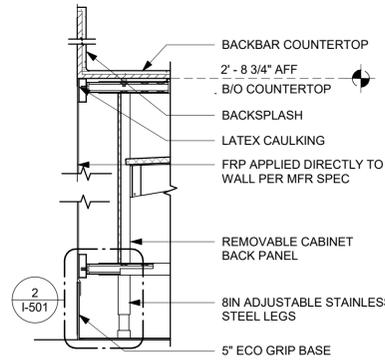


4 WALL TILE ABOVE SS BACKSPLASH  
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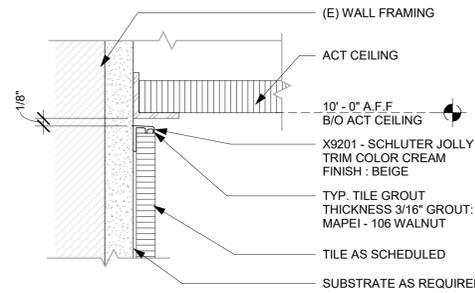
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Wagne Thorne - PX3005 11-09-23  
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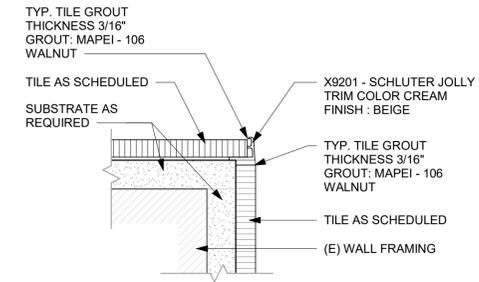
5 CORIAN PANEL ABOVE SST BACKSPLASH  
Scale: 3" = 1'-0"

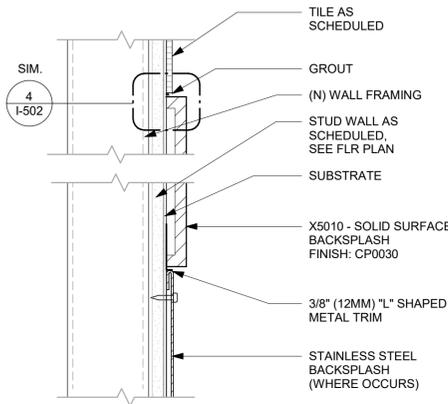


6 BACKBAR WALL TILE PATTERN  
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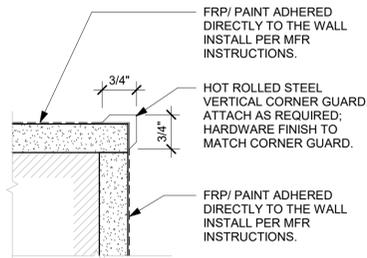
7 TILE TOP TRIM AT CEILING TRANSITION  
Scale: 6" = 1'-0"

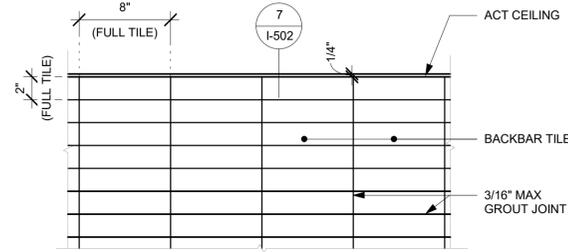


8 TILE CORNER - SCHLUTER TRIM  
Scale: 6" = 1'-0"




9 TRANSITION - TILE TO FRP  
Scale: 6" = 1'-0"

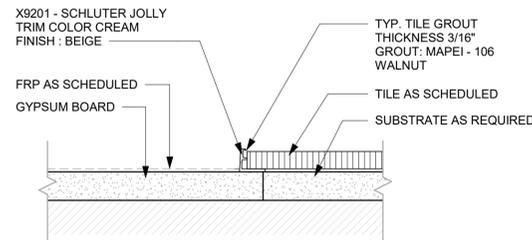

10 10829 - CORNER GUARD DETAIL  
Scale: 6" = 1'-0"

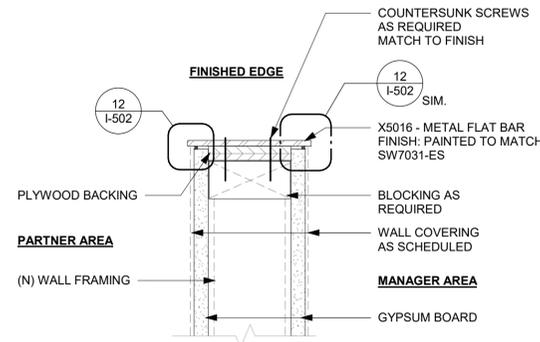

11 X5016 - FINISH EDGE AT MANAGER AREA  
Scale: 3" = 1'-0"

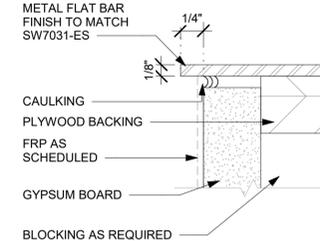

12 CAULKING DETAIL AT METAL  
Scale: 12" = 1'-0"



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FOR CONSTRUCTION

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PROJECT ADDRESS:  
3764 ORLANDO DRIVE  
SANFORD, FL 23773

STORE #: 81065  
PROJECT #: 98504-001  
ISSUE DATE: 08-03-2023  
DESIGNER: PAULINA LOPEZ  
PRODUCTION DESIGNER: ANDY MCLLOUD  
CHECKED BY: DONALD RETHMAN

Revision Schedule			
Rev	Date	By	Description

SHEET TITLE:  
WALL FINISH DETAILS

SCALE: AS SHOWN

SHEET NUMBER:  
I-502

**REVIEWED FOR CODE COMPLIANCE**  
 Wayne Thorne - PX3005 11-09-23  
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PROJECT ADDRESS:  
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 SANFORD, FL 23773**


STORE #: 81065  
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 PRODUCTION DESIGNER: ANDY MCLLOUD  
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Revision Schedule			
Rev	Date	By	Description



SHEET TITLE:  
**INTERIOR DETAILS**

SCALE: 3/4" = 1'-0"


SHEET NUMBER:  
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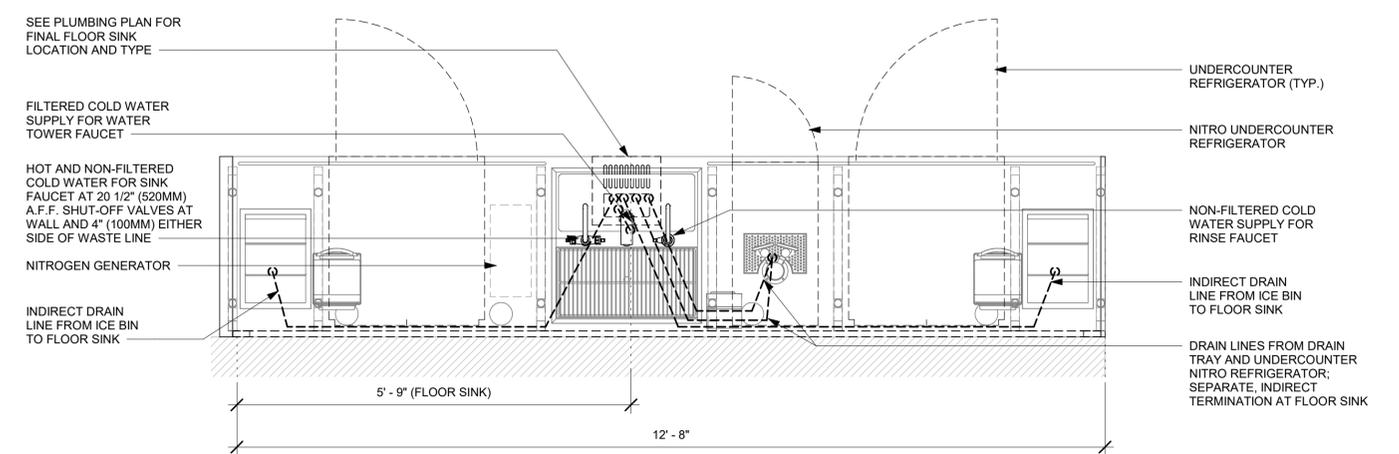
2 HAND SINK - PLUMBING FOR REFERENCE ONLY  
 Scale: 3/4" = 1'-0"

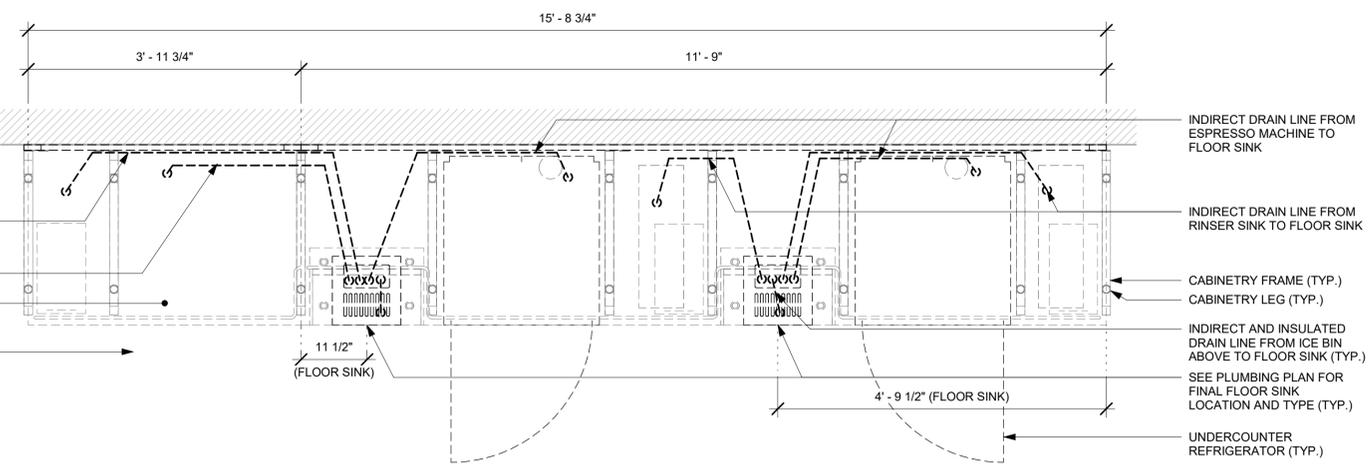

3 BREW - PLUMBING FOR REFERENCE ONLY  
 Scale: 3/4" = 1'-0"

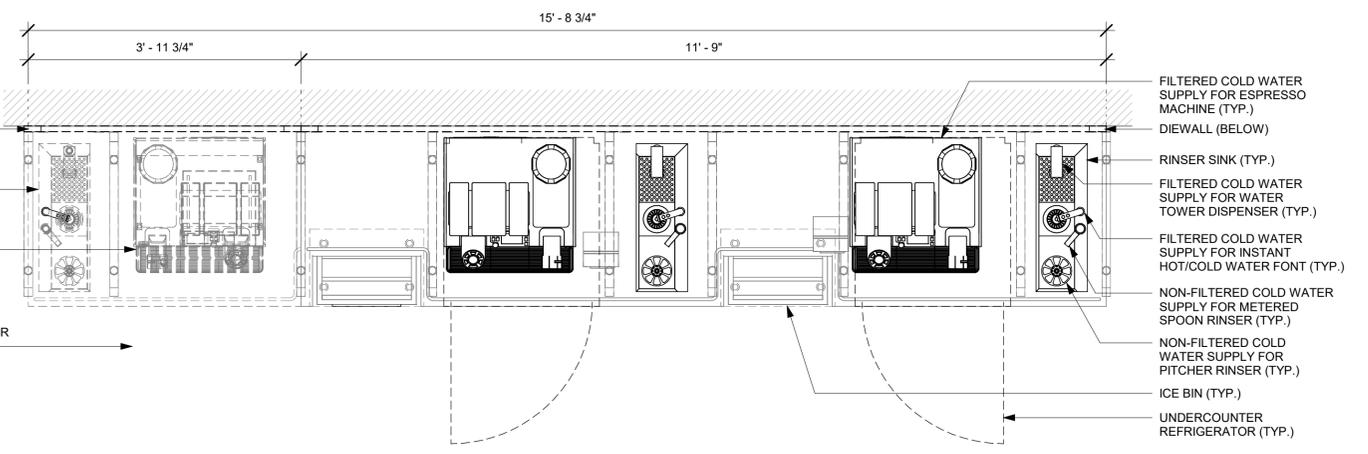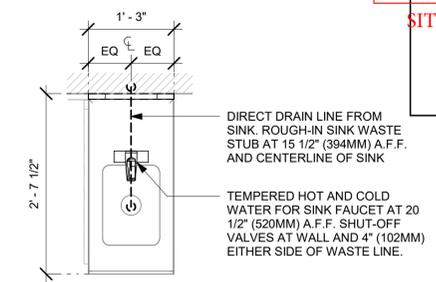


1 ESPRESSO - PLUMBING FOR REFERENCE ONLY  
 Scale: 3/4" = 1'-0"

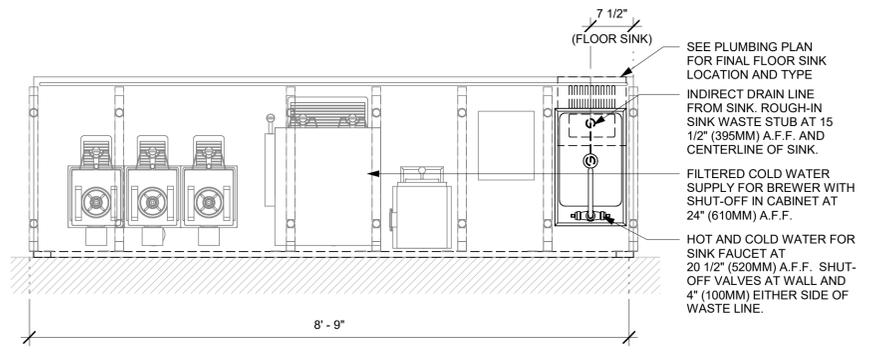



4 CBE - PLUMBING FOR REFERENCE ONLY  
 Scale: 3/4" = 1'-0"

5 ADD HAND SINK - PLUMBING FOR REFERENCE ONLY  
 Scale: 3/4" = 1'-0"

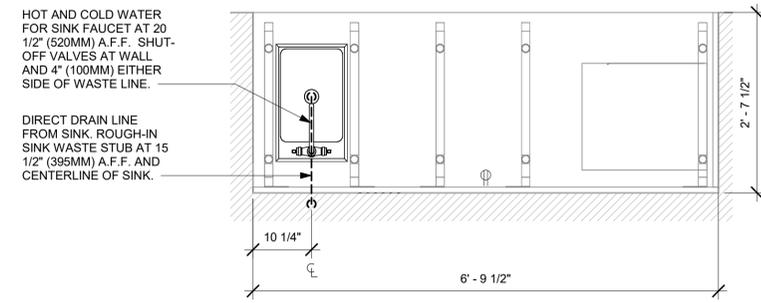


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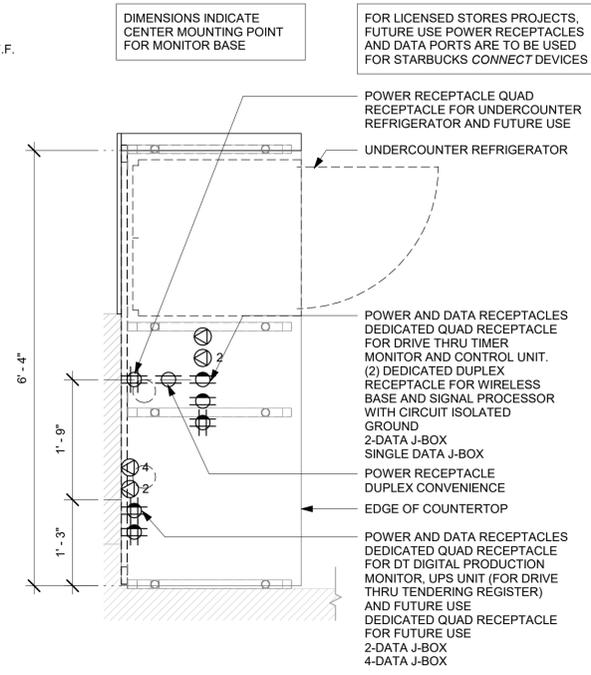
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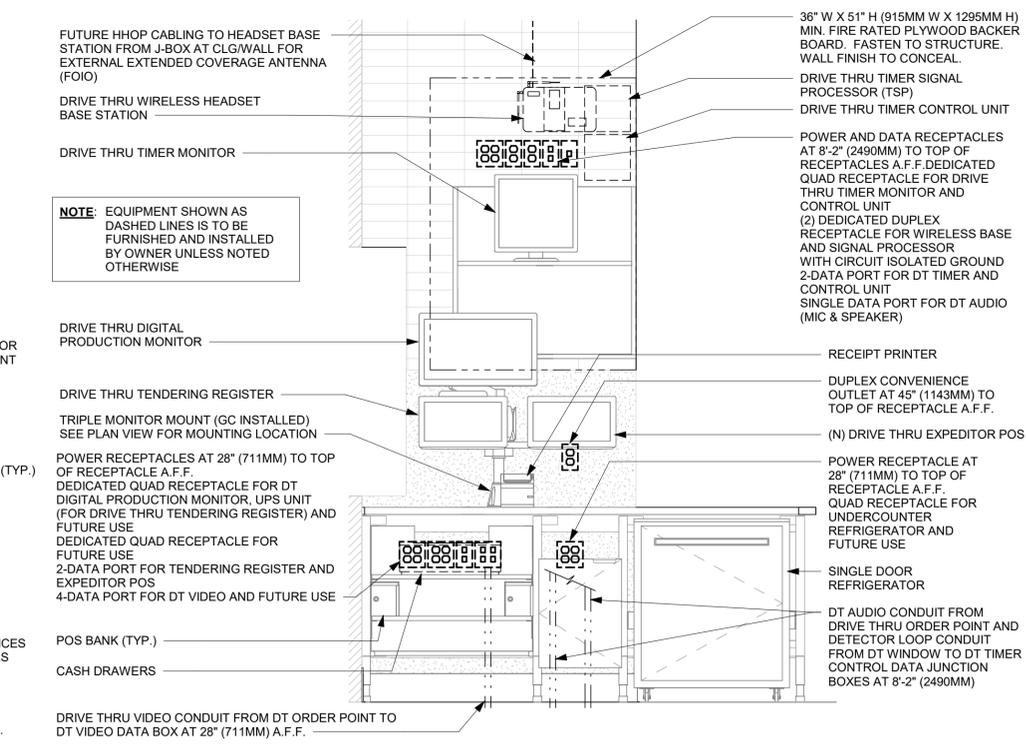
**1 ESPRESSO - ELECTRICAL FOR REFERENCE ONLY**  
Scale: 3/4" = 1'-0"

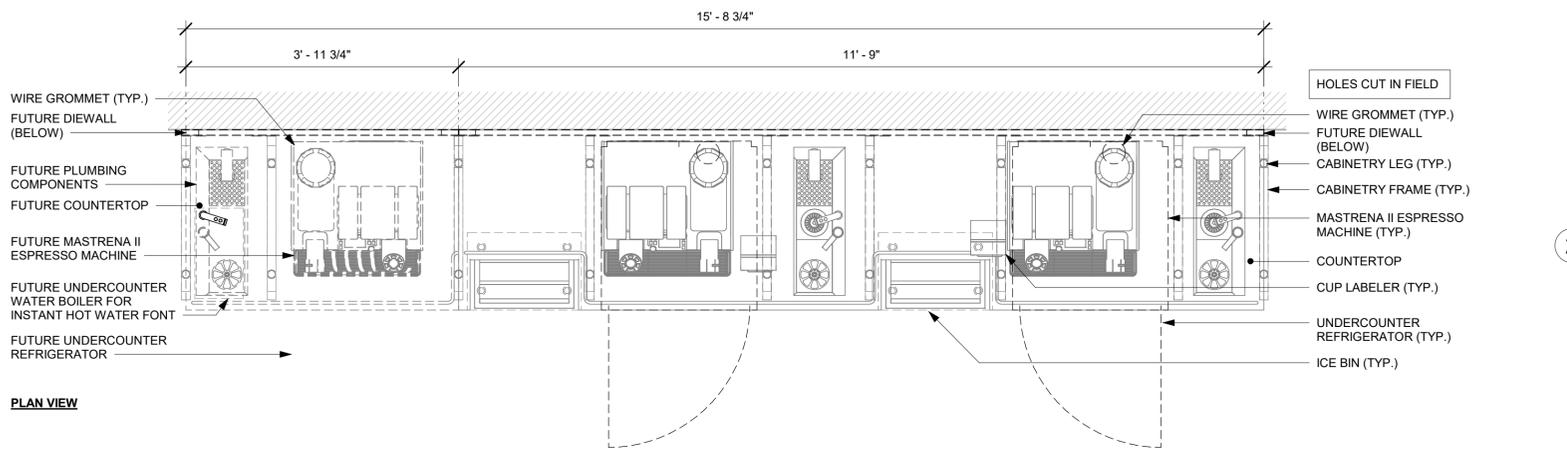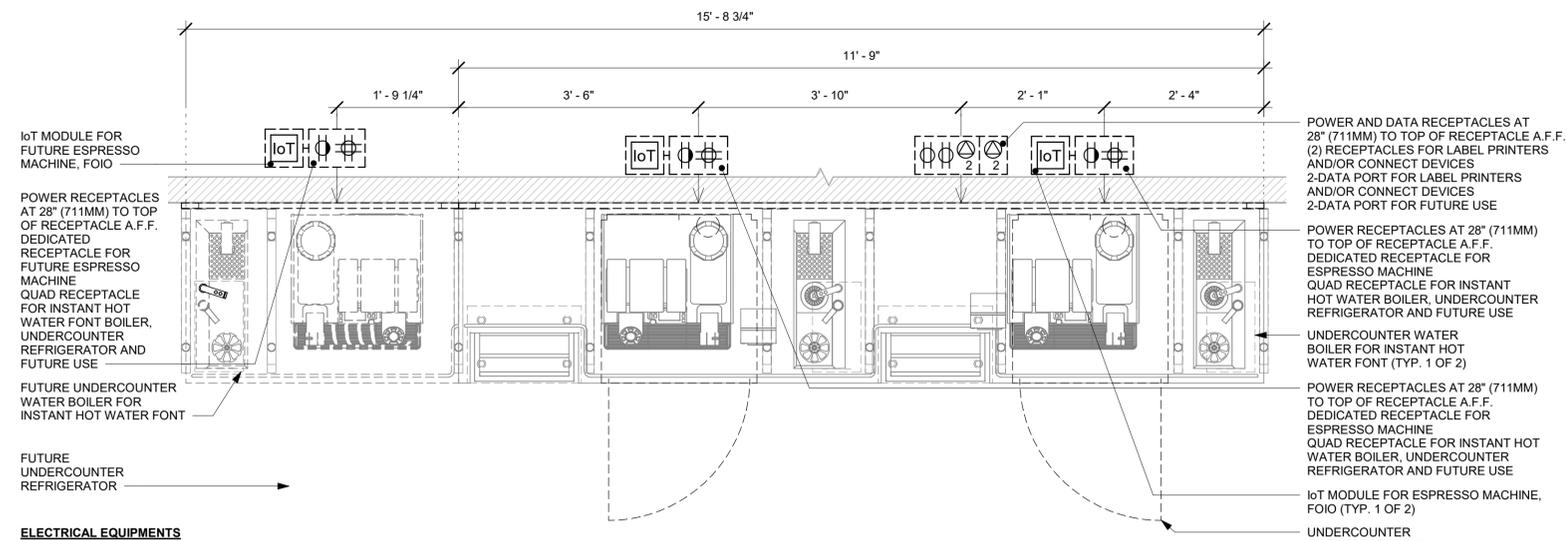

**3 GENERIC METRO BAR MEP DIAGRAM**  
Scale: 3/4" = 1'-0"

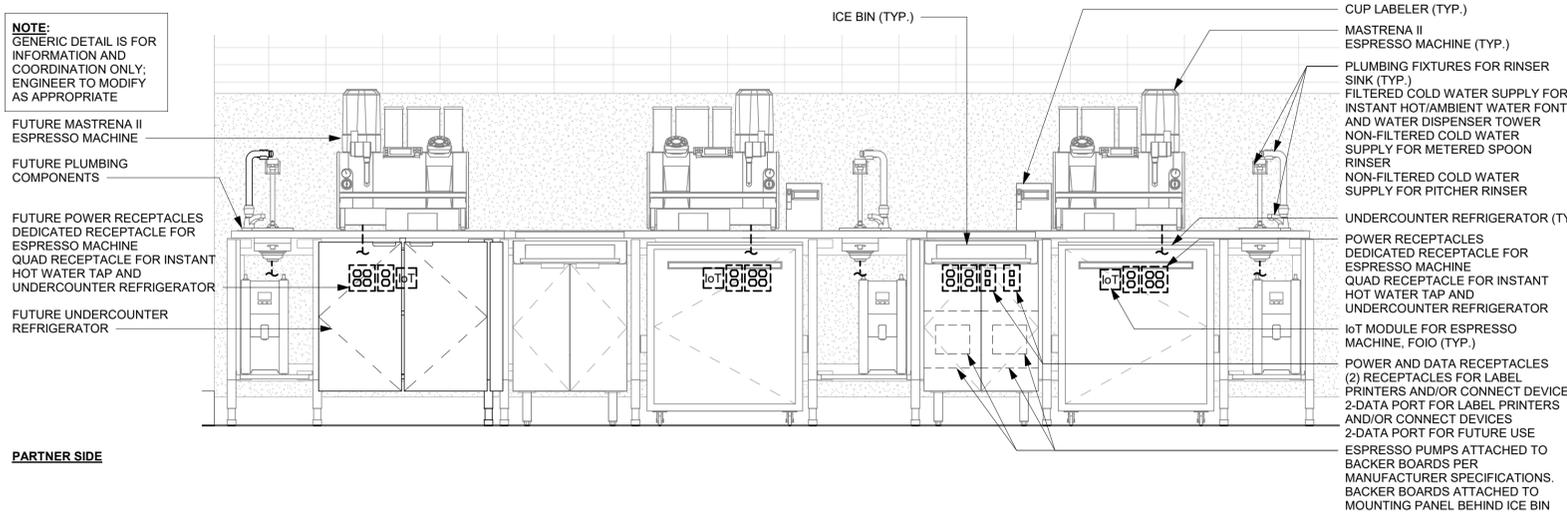

**2 DT POS - ELECTRICAL FOR REFERENCE ONLY**  
Scale: 3/4" = 1'-0"



**4 DRIVE - THRU POS DIAGRAM FOR REFERENCE ONLY**  
Scale: 3/4" = 1'-0"

**REVIEWED FOR CODE COMPLIANCE**  
Wagne Thorne - PX3005 11-09-23  
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Tel: (614) 804-7700

Timothy L. Raberding, PE  
Professional Engineer  
License: 62079



**FOR CONSTRUCTION**

PROJECT NAME:  
**US 17-92 & LAKE MARY BLVD**

PROJECT ADDRESS:  
**3764 ORLANDO DRIVE  
SANFORD, FL 32773**

STORE #: 81065  
PROJECT #: 98504-001  
ISSUE DATE: 08-03-2023  
DESIGNER: PAULINA LOPEZ  
PRODUCTION DESIGNER: ANDY MCLOUD  
CHECKED BY: DONALD RETHMAN

Revision Schedule			
Rev	Date	By	Description

SHEET TITLE:  
**INTERIOR DETAILS**

SCALE: 3/4" = 1'-0"

SHEET NUMBER:  
**I-504**

**REVIEWED FOR CODE COMPLIANCE**  
 Wayne Thorne - PX3005 11-09-23  
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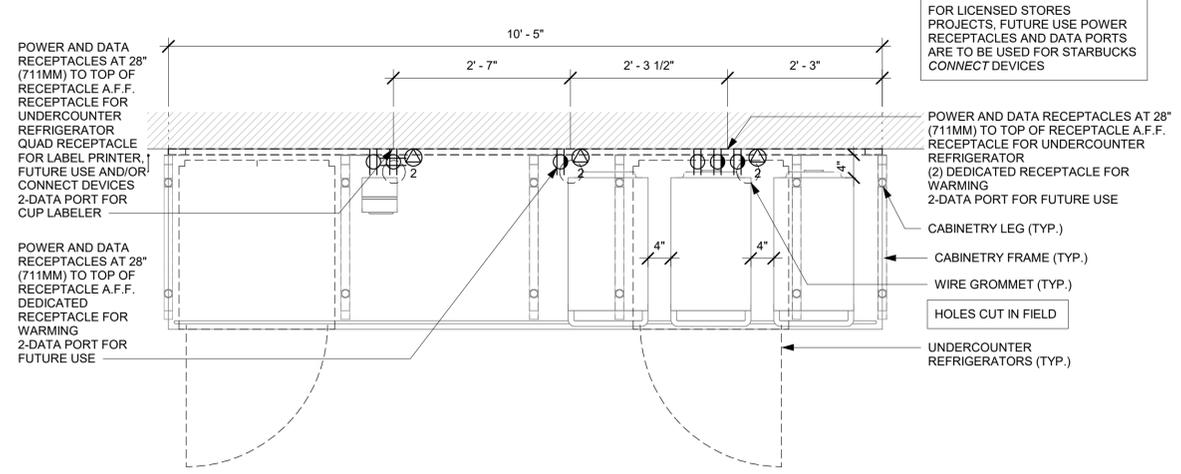
STORE #: 81065  
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 DESIGNER: PAULINA LOPEZ  
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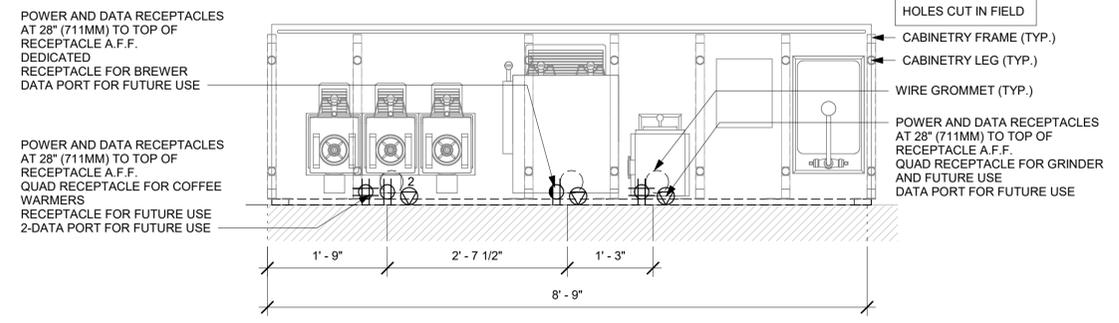
SHEET TITLE:  
**INTERIOR DETAILS**

SCALE: 3/4" = 1'-0"


SHEET NUMBER:  
**I-505**




**1 WARMING - ELECTRICAL FOR REFERENCE ONLY**  
 Scale: 3/4" = 1'-0"




**2 BREW - ELECTRICAL FOR REFERENCE ONLY**  
 Scale: 3/4" = 1'-0"

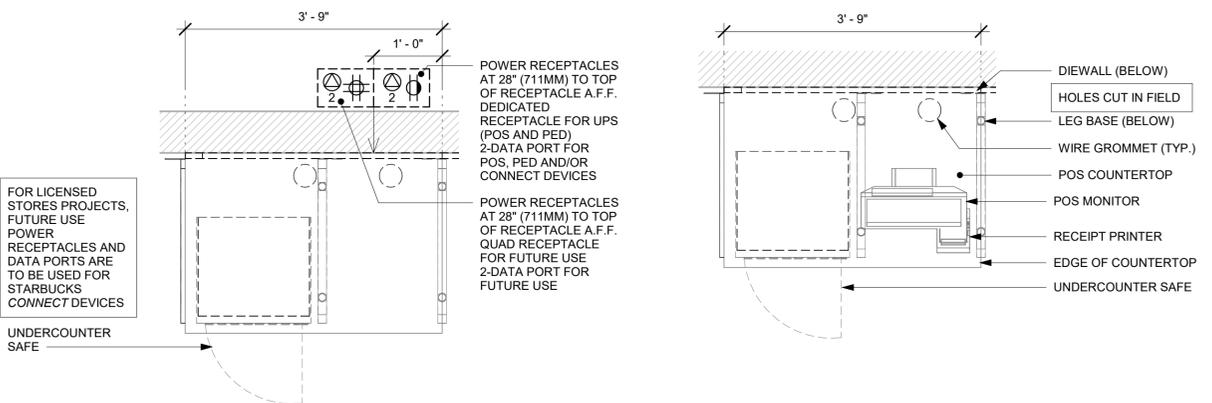

**3 POS - ELECTRICAL FOR REFERENCE ONLY**  
 Scale: 3/4" = 1'-0"

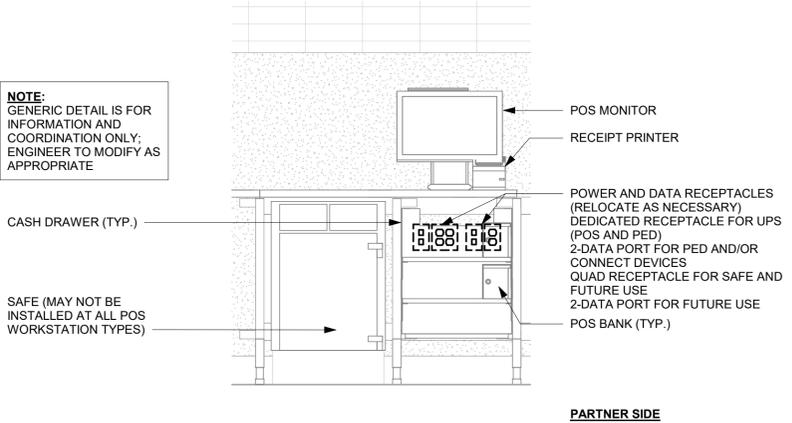

**4 SINGLE POS MEP DIAGRAM FOR REFERENCE ONLY**  
 Scale: 3/4" = 1'-0"

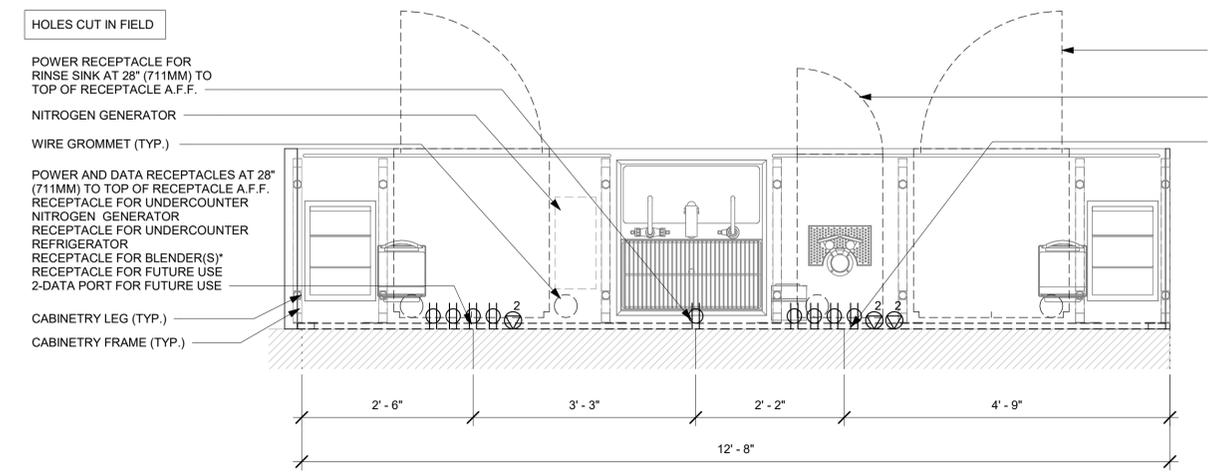

**5 CBE - ELECTRICAL FOR REFERENCE ONLY**  
 Scale: 3/4" = 1'-0"

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 Professional Engineer  
 License: 62078



FOR CONSTRUCTION

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 SANFORD, FL 23773**


STORE #: 81065  
 PROJECT #: 98504-001  
 ISSUE DATE: 08-03-2023  
 DESIGNER: PAULINA LOPEZ  
 PRODUCTION DESIGNER: ANDY MCLLOUD  
 CHECKED BY: DONALD RETHMAN

Revision Schedule			
Rev	Date	By	Description


SHEET TITLE:  
**INTERIOR DETAILS**

SCALE: 3/4" = 1'-0"


SHEET NUMBER:  
**I-506**

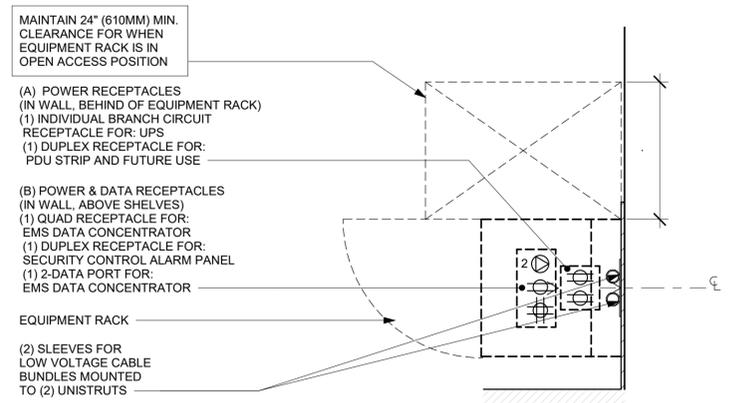

PLAN VIEW

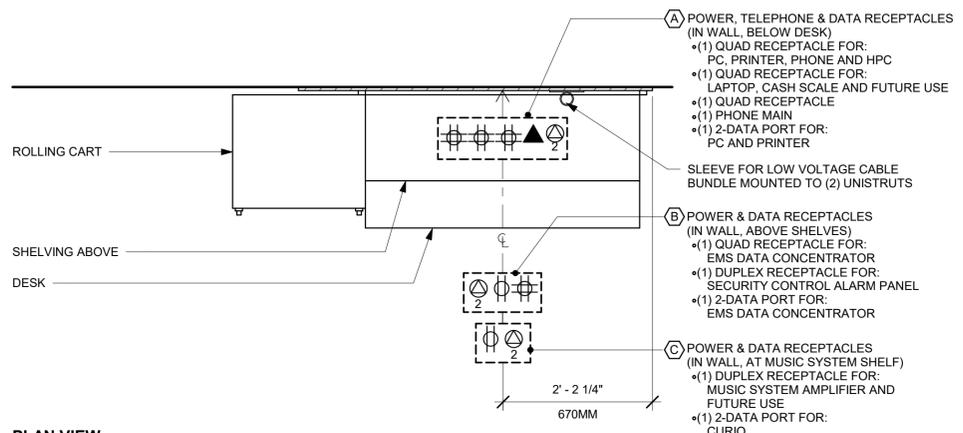



PLAN VIEW

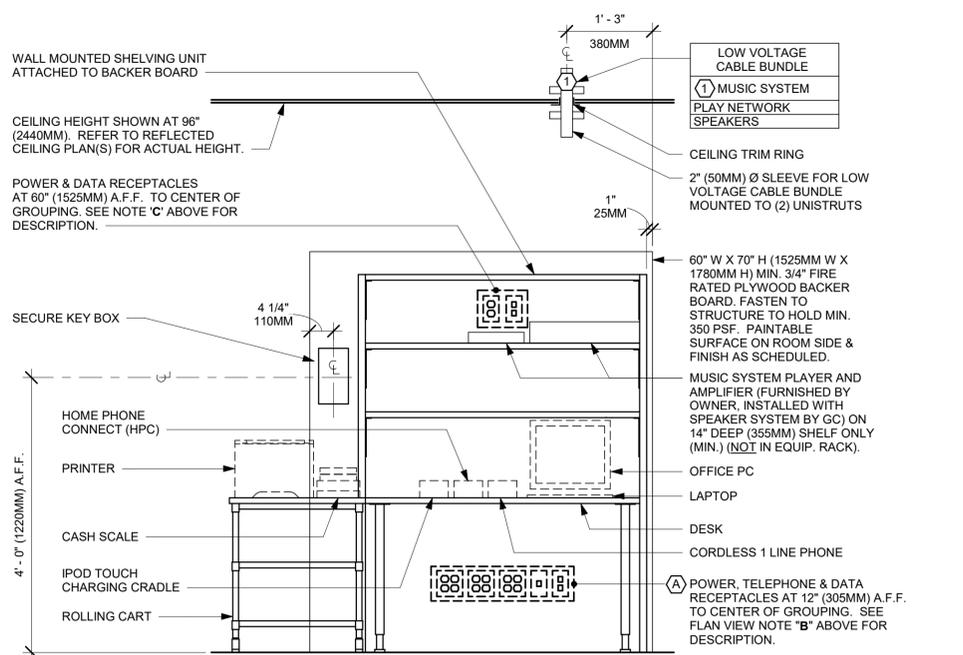

ELEVATION VIEW

NOTE: EQUIPMENT SHOWN AS DASHED LINES IS TO BE FURNISHED AND INSTALLED BY OWNER UNLESS NOTED OTHERWISE.

1 MANAGER DESK (NEW) - LEFT - ELECTRICAL  
 Scale: 3/4" = 1'-0"

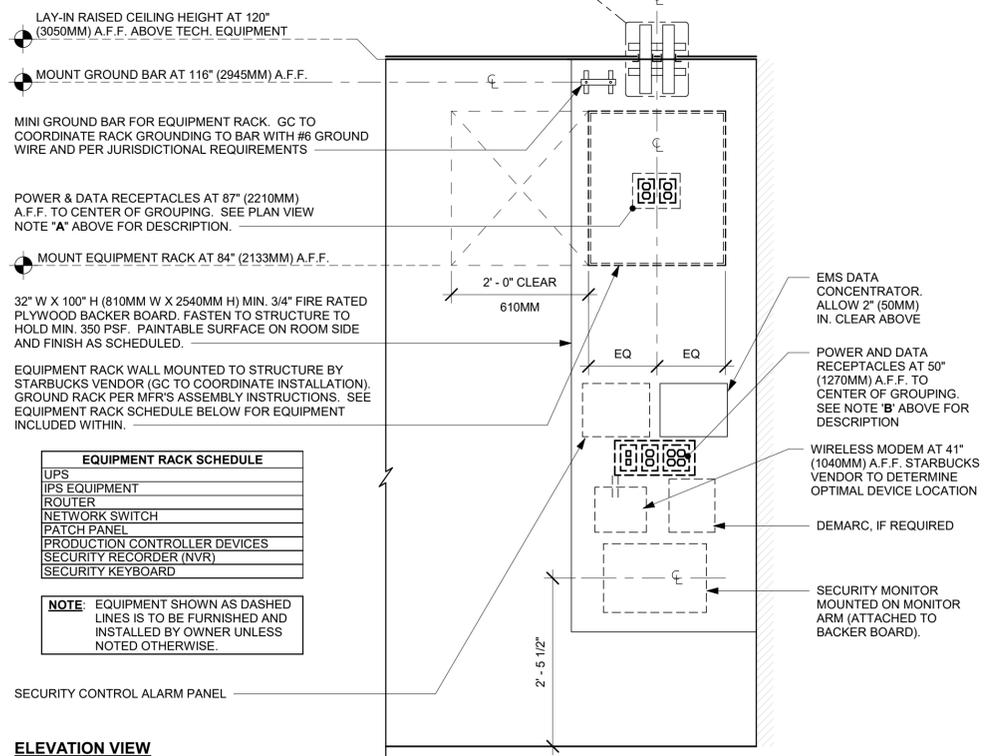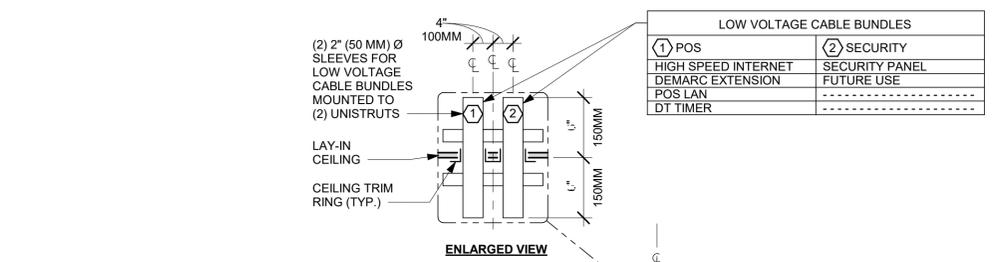

ELEVATION VIEW

2 EQUIPMENT RACK LEFT - ELECTRICAL  
 Scale: 3/4" = 1'-0"

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 Wayne Thorne - PX3005 11-09-23  
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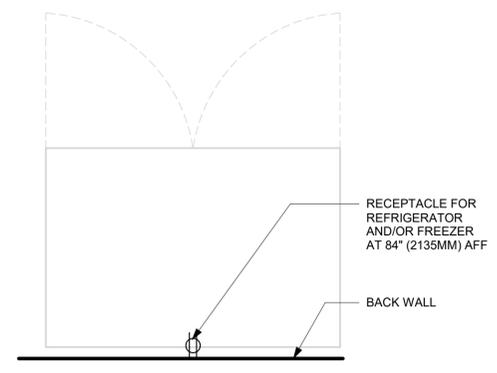
STORE #: 81065  
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 DESIGNER: PAULINA LOPEZ  
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Revision Schedule			
Rev	Date	By	Description


SHEET TITLE:  
**INTERIOR DETAILS**

SCALE: 3/4" = 1'-0"


SHEET NUMBER:  
**I-507**




**1 REFRIGERATOR/FREEZER - ELECTRICAL**  
 Scale: 3/4" = 1'-0"

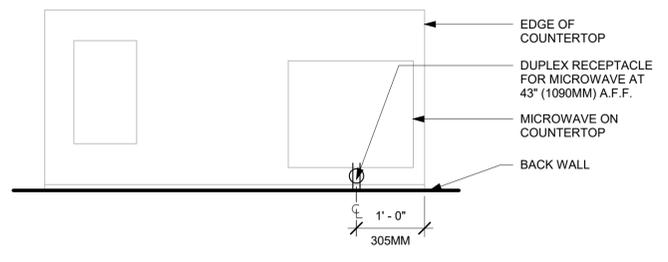


**2 PARTNER AMENITY STATION - ELECTRICAL**  
 Scale: 3/4" = 1'-0"

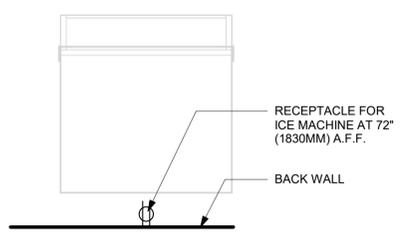


**3 ICE MACHINE - ELECTRICAL**  
 Scale: 3/4" = 1'-0"

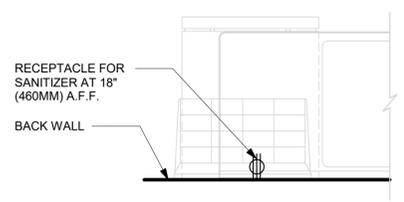

**4 SANITIZING WORKSTATION - ELECTRICAL**  
 Scale: 3/4" = 1'-0"

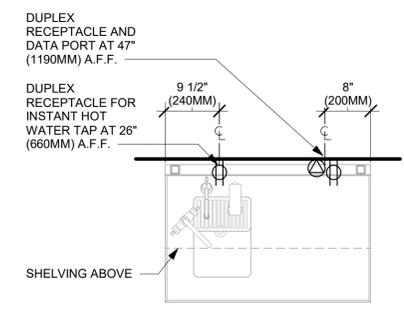


**5 WATER FILLING STATION - ELECTRICAL**  
 Scale: 3/4" = 1'-0"

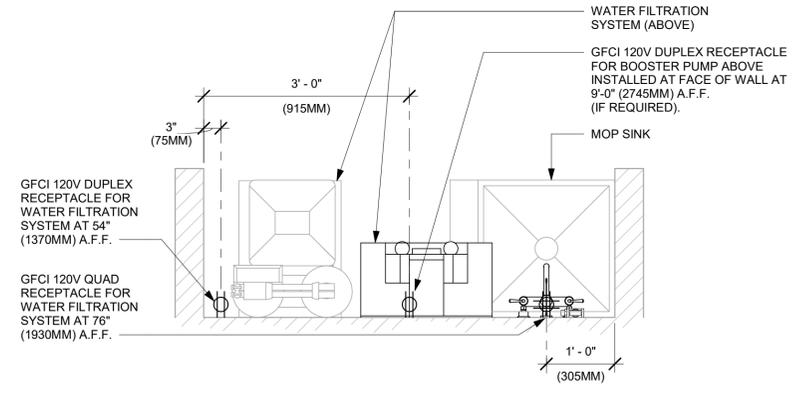


**6 WATER FILTRATION - CONFIGURATION III**  
 Scale: 3/4" = 1'-0"

NOTE:  
SHOP DRAWINGS TO BE APPROVED BY  
SB DESIGNER PRIOR TO FABRICATION.

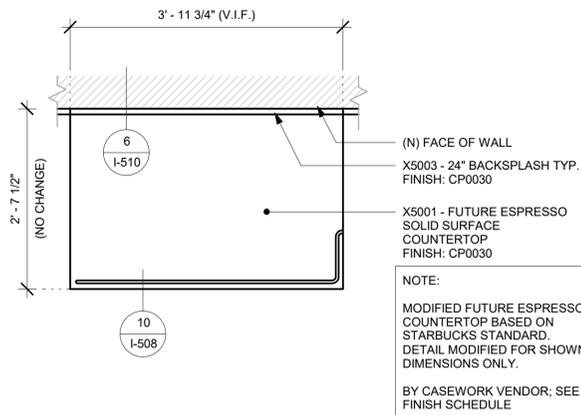


NOTE:  
MODIFIED FUTURE ESPRESSO  
COUNTERTOP BASED ON  
STARBUCKS STANDARD.  
DETAIL MODIFIED FOR SHOWN  
DIMENSIONS ONLY.  
BY CASEWORK VENDOR; SEE  
FINISH SCHEDULE

NOTE:  
MODIFIED ADD PARTNER COUNTERTOP BASED  
ON STARBUCKS STANDARD.  
DETAIL MODIFIED FOR SHOWN DIMENSIONS  
ONLY.  
BY CASEWORK VENDOR; SEE FINISH SCHEDULE

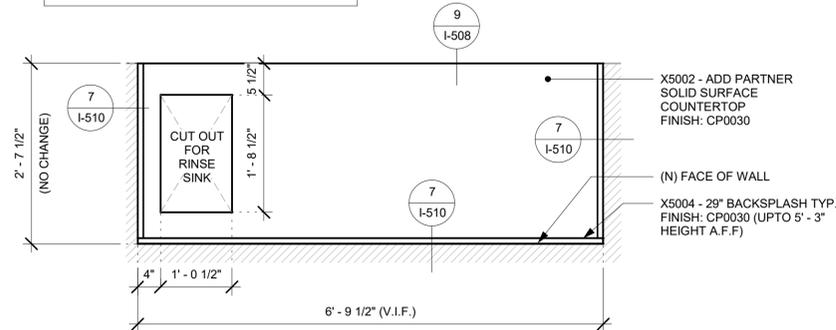

NOTE:  
MODIFIED DT ADD  
COUNTERTOP BASED ON  
STARBUCKS STANDARD.  
DETAIL MODIFIED FOR  
SHOWN DIMENSIONS ONLY.  
BY CASEWORK VENDOR;  
SEE FINISH SCHEDULE

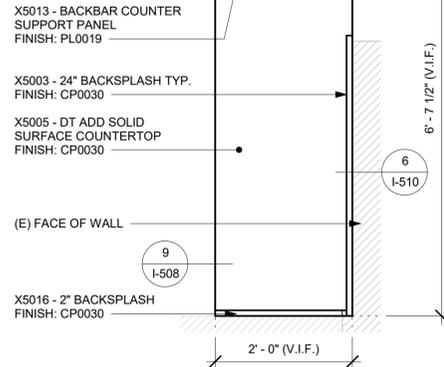

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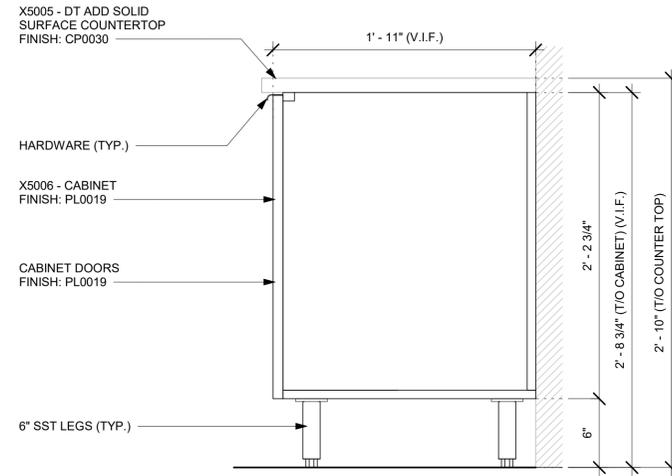
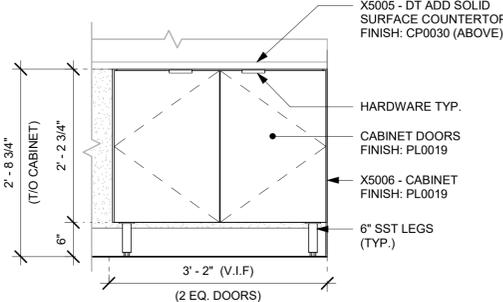
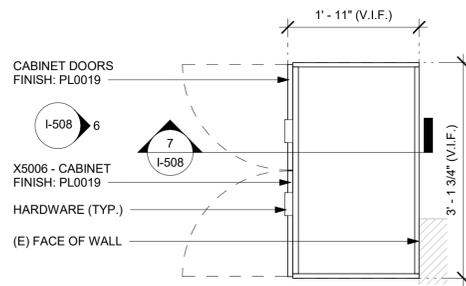
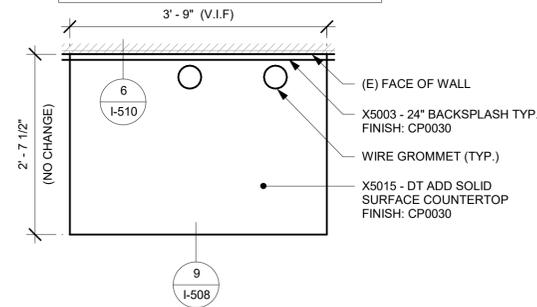
SITE COPY **BC23-000692**

1 X5001 - FUTURE ESPRESSO COUNTERTOP - PLAN  
Scale: 3/4" = 1'-0"

2 X5002 - ADD PARTNER COUNTERTOP - PLAN  
Scale: 3/4" = 1'-0"

3 X5005 - DT ADD COUNTERTOP - PLAN  
Scale: 3/4" = 1'-0"

NOTE:  
MODIFIED DT POS COUNTERTOP BASED ON  
STARBUCKS STANDARD.  
DETAIL MODIFIED FOR SHOWN DIMENSIONS ONLY.  
BY CASEWORK VENDOR; SEE FINISH SCHEDULE




4 X5015 - DT POS COUNTERTOP - PLAN  
Scale: 3/4" = 1'-0"

5 X5006 - UNDERCOUNTER CABINET - PLAN  
Scale: 3/4" = 1'-0"


6 X5006 - UNDERCOUNTER CABINET - ELEVATION  
Scale: 3/4" = 1'-0"

7 X5006 - UNDERCOUNTER CABINET - SECTION  
Scale: 1 1/2" = 1'-0"

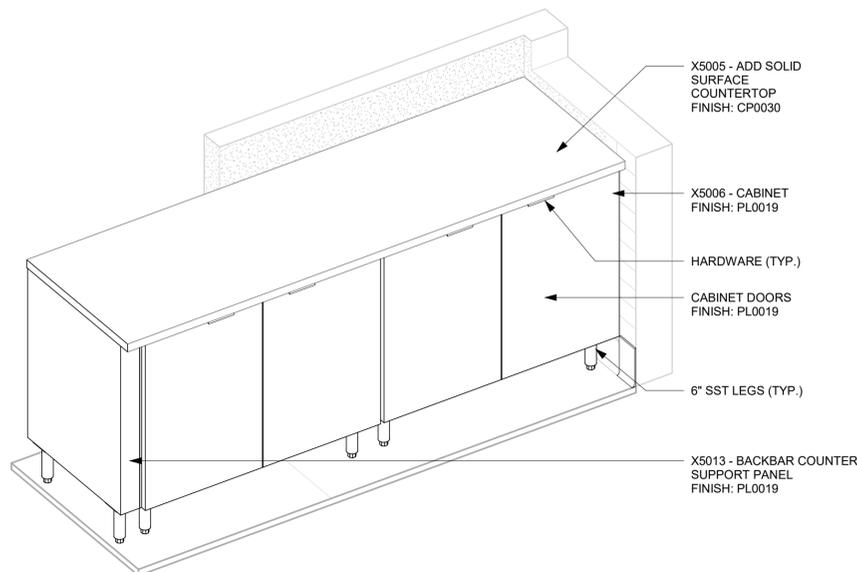


8 X5006 - DT UNDERCOUNTER CABINET - 3D VIEW  
Scale:

NOTE: FOR REF ONLY. MATCH  
EXIST COUNTERTOP EDGE  
DETAIL WHEN APPLICABLE.

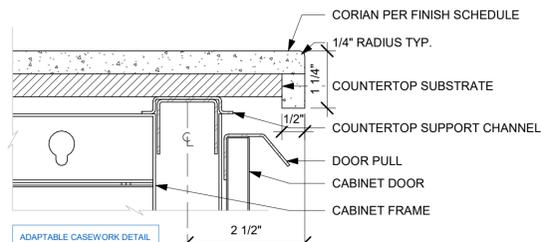

9 TYP. CORIAN EDGE - FRONTLINE  
Scale: 6" = 1'-0"

NOTE: FOR REF ONLY. MATCH  
EXIST COUNTERTOP EDGE  
DETAIL WHEN APPLICABLE.

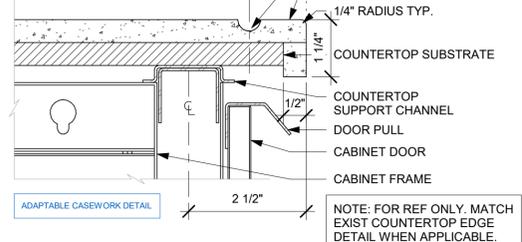

10 TYP. CORIAN DRIP EDGE - FRONTLINE  
Scale: 6" = 1'-0"

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**US 17-92 & LAKE MARY  
BLVD**

PROJECT ADDRESS:  
**3764 ORLANDO DRIVE  
SANFORD, FL 23773**

STORE #: 81065  
PROJECT #: 98504-001  
ISSUE DATE: 08-03-2023  
DESIGNER: PAULINA LOPEZ  
PRODUCTION DESIGNER: ANDY MCLLOUD  
CHECKED BY: DONALD RETHMAN

Revision Schedule			
Rev	Date	By	Description

SHEET TITLE:  
**INTERIOR DETAILS**

SCALE: AS SHOWN

SHEET NUMBER:  
**I-508**

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Timothy L. Raberding, PE  
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**FOR CONSTRUCTION**

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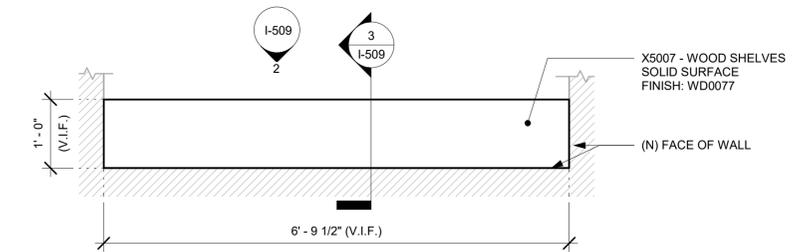
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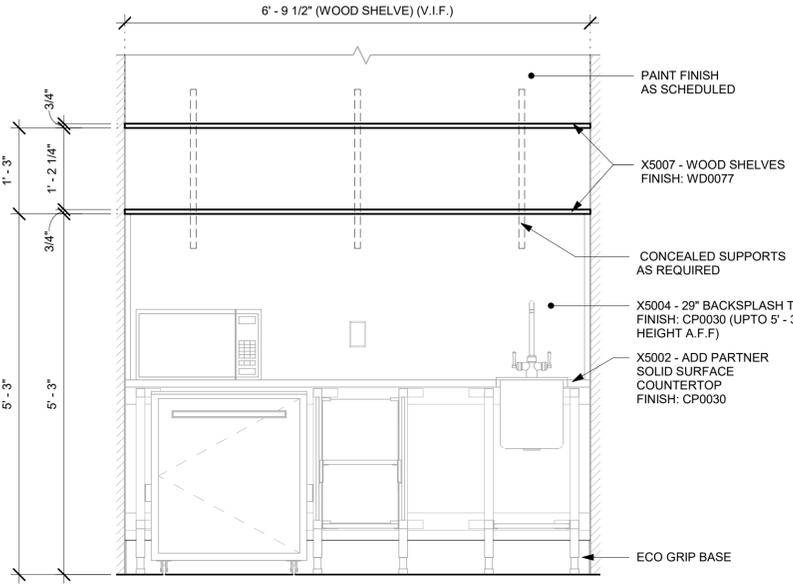
SHEET TITLE:  
**INTERIOR DETAILS**

SCALE: AS SHOWN


SHEET NUMBER:  
**I-509**




**1 X5007 - WOOD SHELVES - PLAN**  
Scale: 3/4" = 1'-0"




**2 X5007 - WOOD SHELVES - ELEVATION**  
Scale: 3/4" = 1'-0"

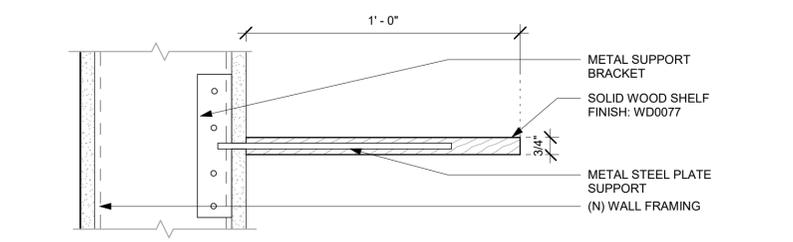


**6 WOOD SHELVES FIXING DETAIL**  
Scale: 3" = 1'-0"

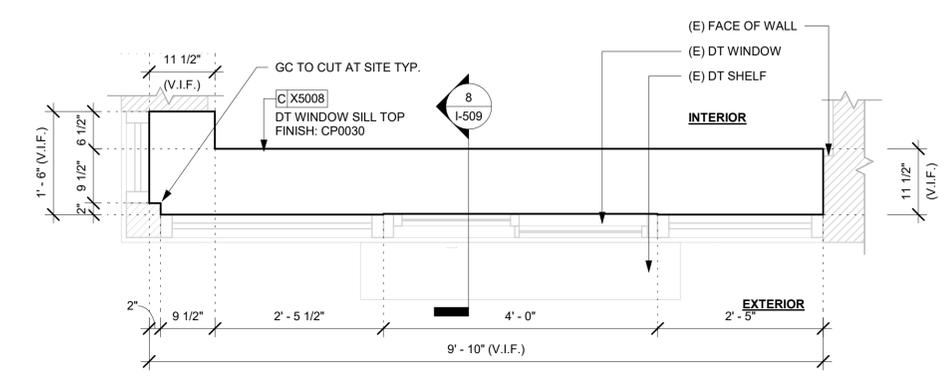


**7 X5008 - DT SILL TOP - PLAN**  
Scale: 3/4" = 1'-0"

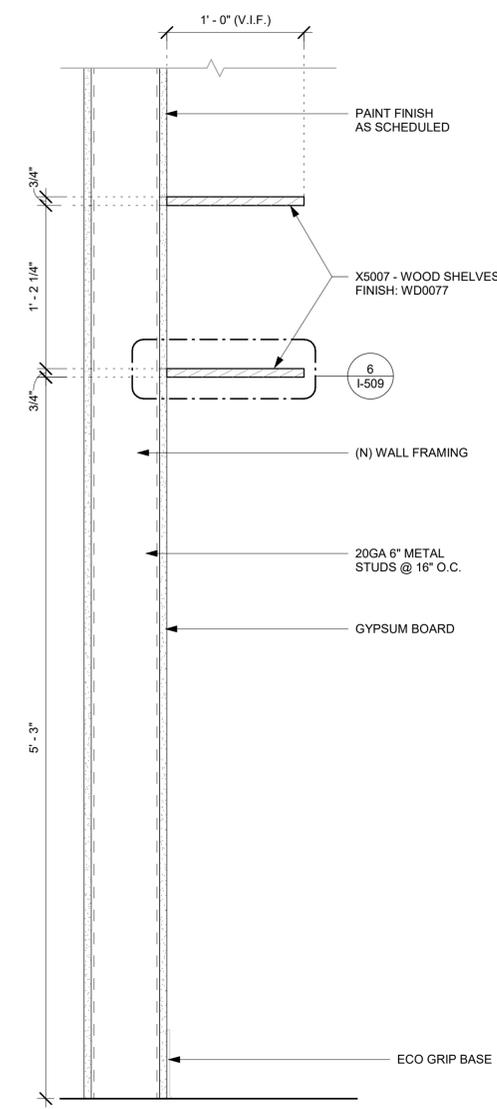


**3 X5007 - WOOD SHELVES - SECTION**  
Scale: 1 1/2" = 1'-0"

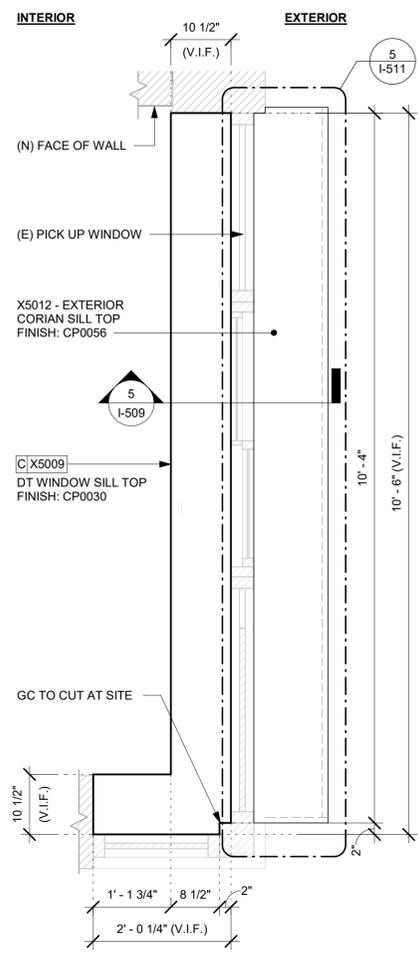

**4 X5009 - PICK UP WINDOW SILL TOP - PLAN**  
Scale: 3/4" = 1'-0"

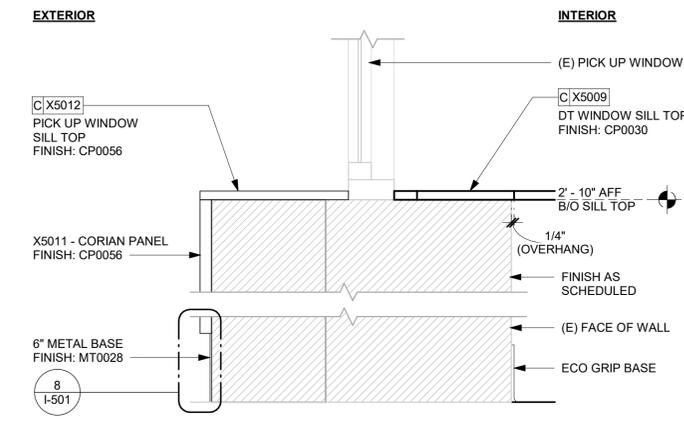

**5 X5009 - PICK UP WINDOW SILL TOP - SECTION**  
Scale: 1 1/2" = 1'-0"

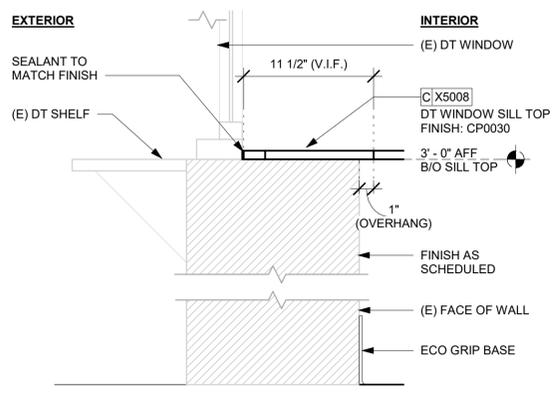

**8 X5008 - DT SILL TOP - SECTION**  
Scale: 1 1/2" = 1'-0"

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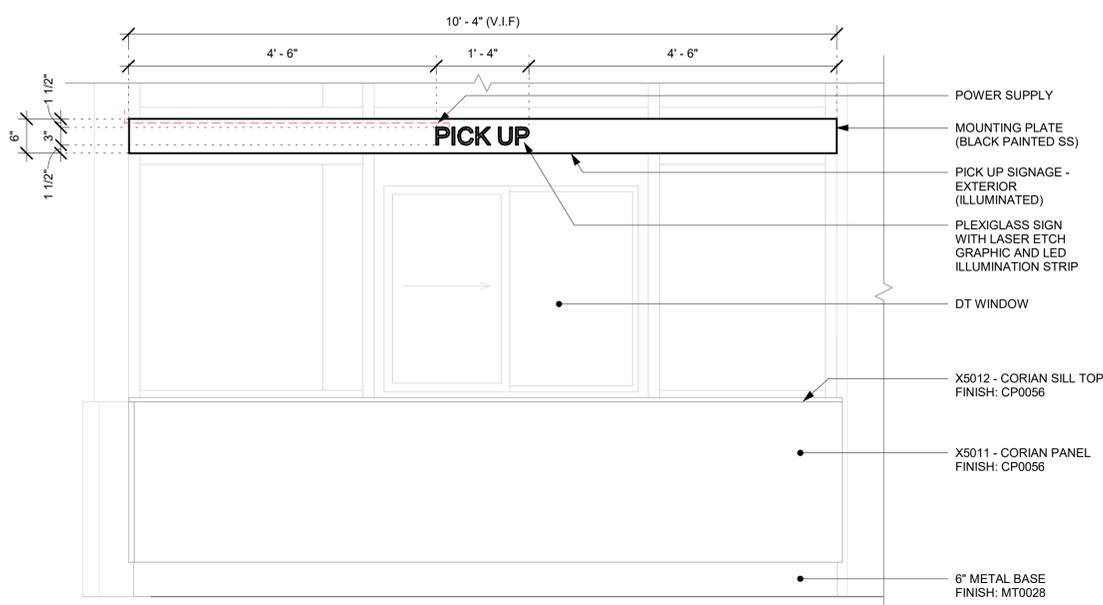
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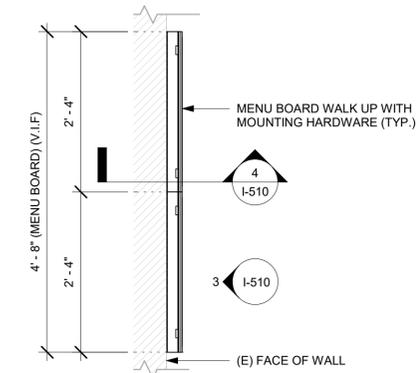
SHEET TITLE:  
**INTERIOR DETAILS**

SCALE: AS SHOWN


SHEET NUMBER:  
**I-510**



**1 X0002 - PICK UP SIGNAGE - ELEVATION**  
Scale: 3/4" = 1'-0"



**2 MENU BOARD WALK UP - PLAN**  
Scale: 3/4" = 1'-0"

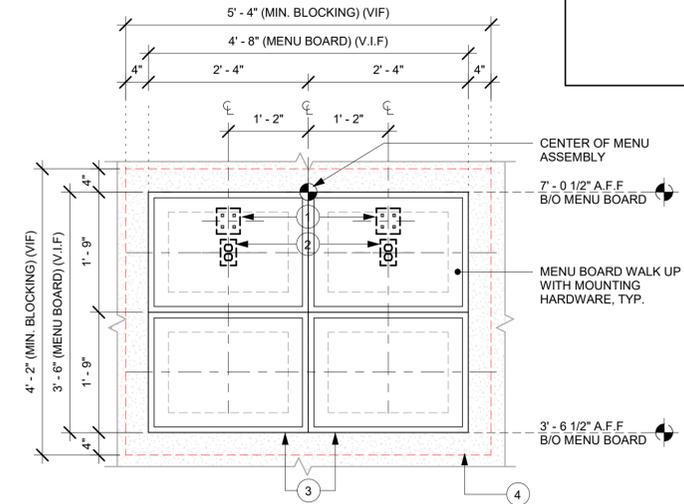


- ① (2) QUAD OUTLETS
- ② (2) DUAL DATA PORTS
- ③ MENU BOARD FRAME/BACKET (CURRENT)
- ④ 3/4" PLYWOOD BLOCKING SECURED TO STRUCTURE TO EXTEND A MIN. 4" PAST EDGE OF MENU BOARDS


DESIGNER/CONSULTANT TO ADAPT DETAIL BASED ON STORE SPECIFIC MENU BOARD EQUIPMENT PER SDRG GUIDELINES FOR DIGITAL MENU BOARDS.

**NOTE:** ELECTRICAL AND LOW VOLTAGE COMPONENTS ARE FOR FUTURE DIGITAL MENU BOARDS.


**3 MENU BOARD WALK UP - ELEVATION**  
Scale: 3/4" = 1'-0"

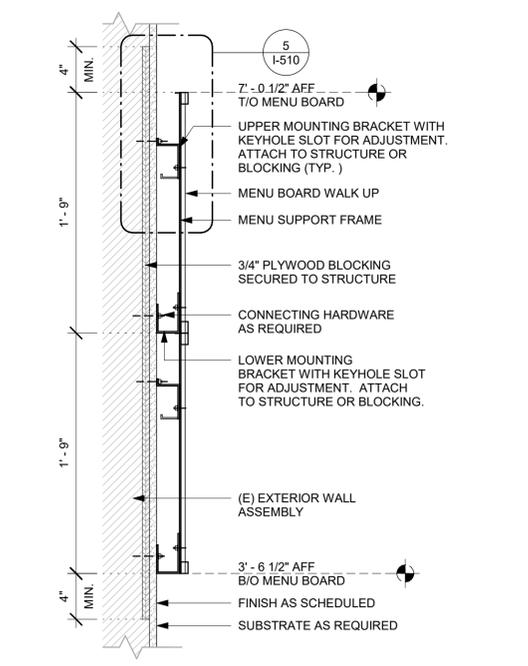


**4 MENU BOARD WALK UP - SECTION**  
Scale: 1 1/2" = 1'-0"

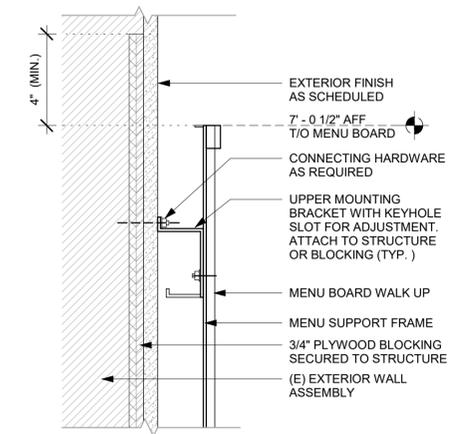

**5 MENU BOARD FIXING DETAIL**  
Scale: 3" = 1'-0"

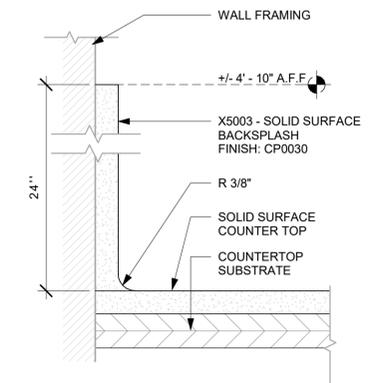


**6 24" BACKSPLASH DETAIL**  
Scale: 6" = 1'-0"

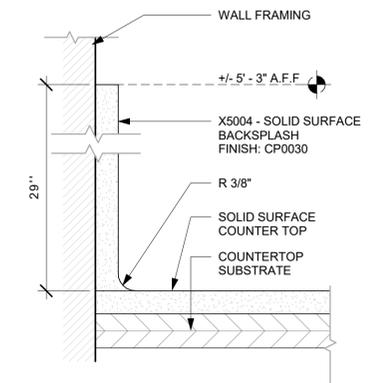


**7 29" BACKSPLASH DETAIL**  
Scale: 6" = 1'-0"

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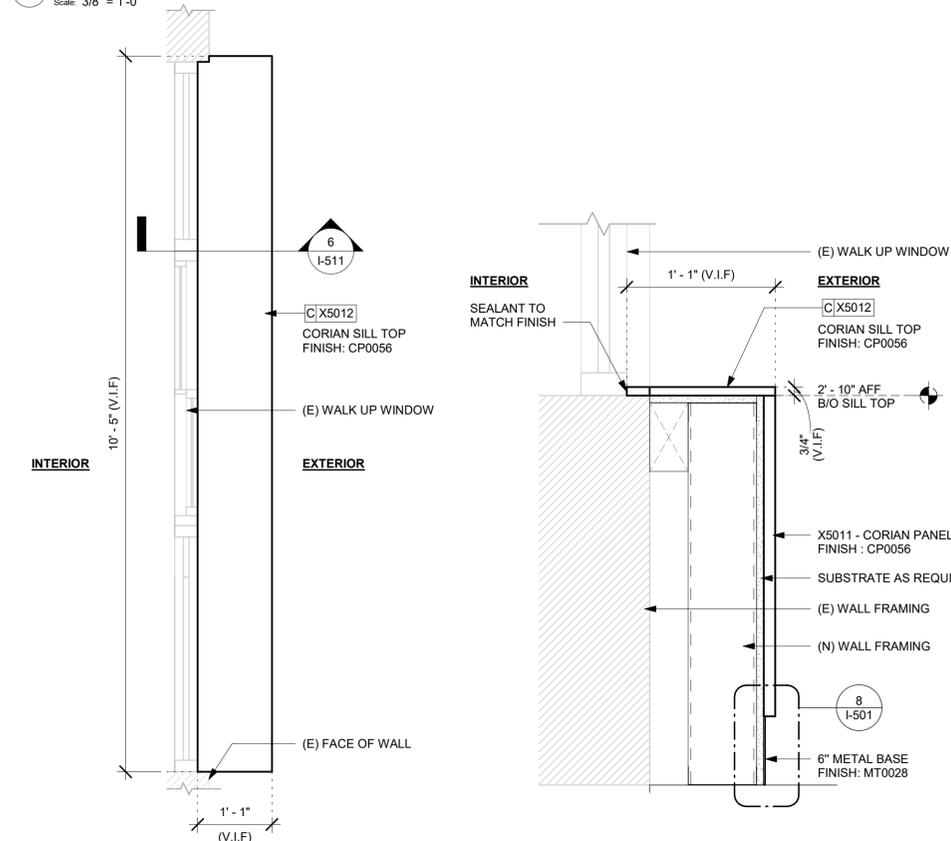
NOTE:  
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1 LOUVERS - PLAN  
Scale: 3/8" = 1'-0"

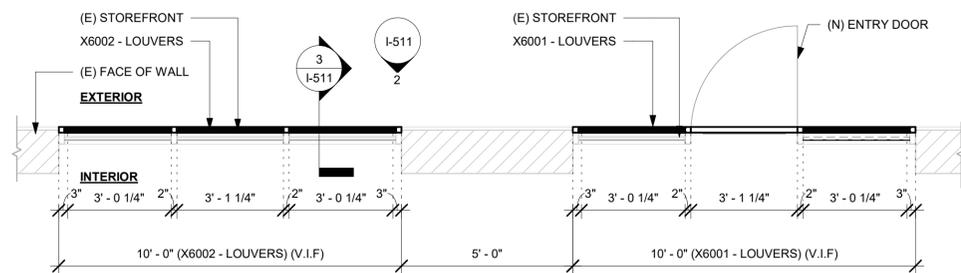


2 LOUVERS - ELEVATION  
Scale: 3/8" = 1'-0"

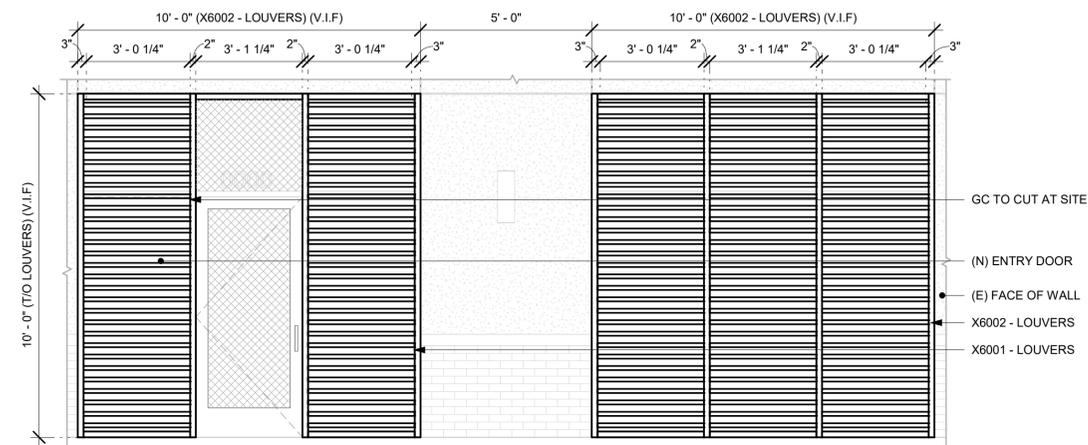


5 X5012 - CORIAN SILL TOP - PLAN  
Scale: 3/4" = 1'-0"

6 X5012 - CORIAN SILL TOP - SECTION  
Scale: 1 1/2" = 1'-0"

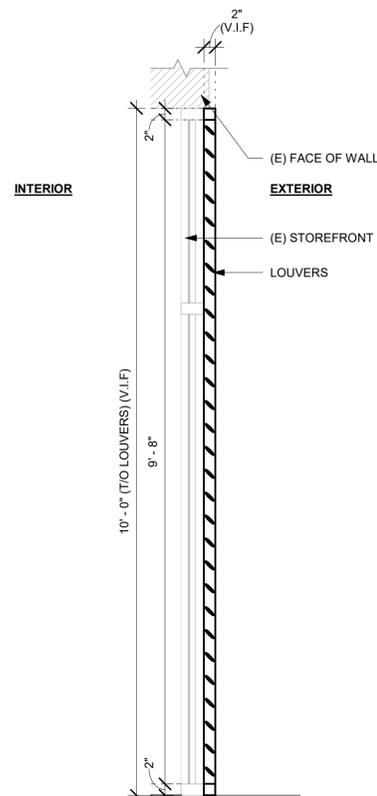

3 LOUVERS - SECTION  
Scale: 3/4" = 1'-0"

NOTES:  
1. LOCATE PUMP WITHIN CORD LENGTH LIMIT. ORIENT WITH PUMP HEAD LEFT, RIGHT AND AT BOTTOM. LOOSEN PUMP HEAD CLAMP, ROTATE AND RE-TIGHTEN AS REQUIRED PER ORIENTATION TO PROVIDE FRONT ACCESS TO FLOW. ADJUSTMENT WITHIN CORD LENGTH LIMIT.  
2. USE LOCKTITE ON ISOLATOR THREADS. DO NOT OVER TIGHTEN.  
3. LOOSEN PUMP HEAD CLAMP, ROTATE AND RE-TIGHTEN AS REQUIRED FOR PUMP ORIENTATION.  
4. EACH BACKER BOARD'S ASSEMBLY COMPONENTS INCLUDE:  
(1) BACKER BOARDS  
(2) TENETS, 1/4-20 VENDOR MOUNTED  
(8) WOOD SCREWS #8 1-1/4" (32MM)  
(4) NEOPRENE ISOLATORS, KARMAN RUBBER, K84-60 NEOPRENE  
(4) LOCK NUTS, 1/4-20 NYLON  
(4) WASHERS, 1/4" (7MM) FLAT  
STEEL SUPPORT FRAME PER CASEWORK SHOP DRAWINGS  
23.685" H X 12" W (602MM X 305MM),  
3/4" MARINE GRADE PLYWOOD  
BACKER BOARD SECURED TO STEEL FRAME WITH THRU BOLTS AND SILICONE ADHESIVE PER CASEWORK SHOP DRAWINGS  
SEE NOTES ABOVE FOR ASSEMBLY ITEMS  
PUMP ATTACHED TO BACKER BOARD WITH ASSEMBLY COMPONENTS  
10"X10" (250MM X 250MM) BACKER BOARD. ATTACH TO PLYWOOD SUBSTRATE WITH SILICONE ADHESIVE AND WOOD SCREWS. SILICONE PERIMETER.  
FINISHED FLOOR

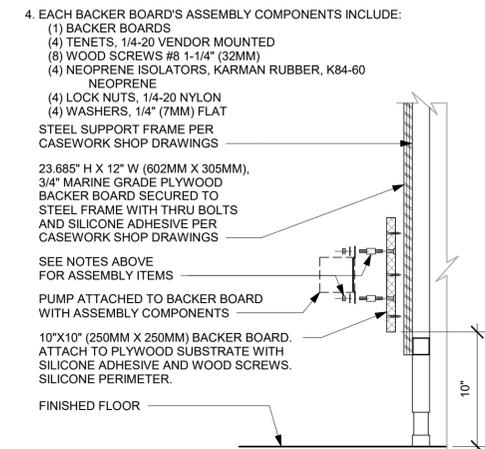

4 ESPRESSO PUMP MOUNTED AT CABINET  
Scale: 1 1/2" = 1'-0"

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11/06/2023

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SHEET TITLE:  
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SCALE: AS SHOWN

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I-511

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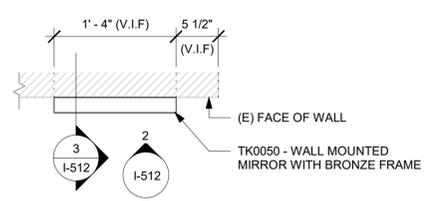
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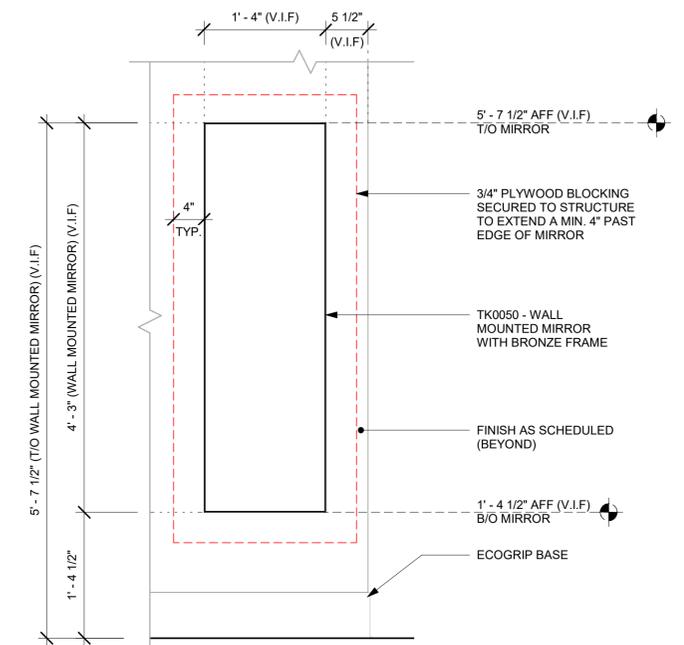
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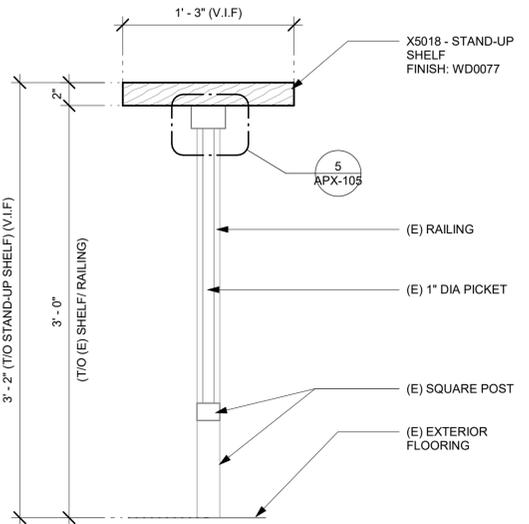
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**I-512**




1 TK0050 - MIRROR - PLAN  
Scale: 1" = 1'-0"




2 TK0050 - MIRROR - ELEVATION  
Scale: 1" = 1'-0"




6 X5018 - STAND UP SHELF - SECTION  
Scale: 1 1/2" = 1'-0"

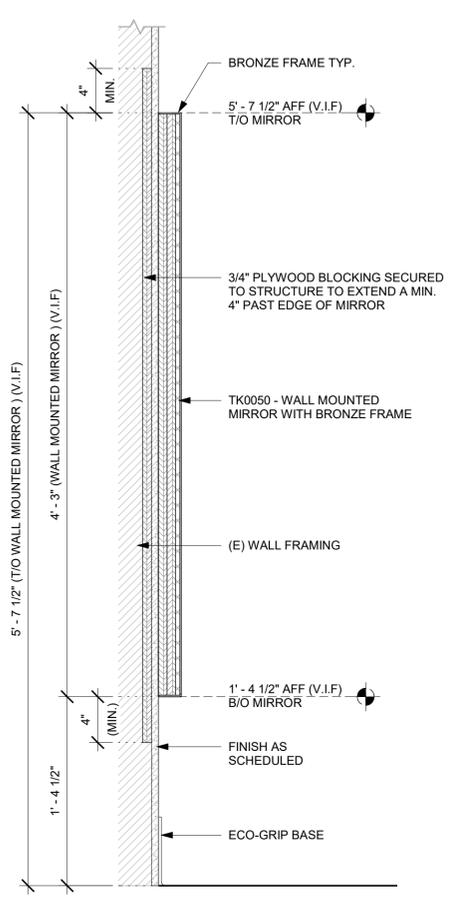

3 TK0050 - MIRROR - SECTION  
Scale: 1 1/2" = 1'-0"

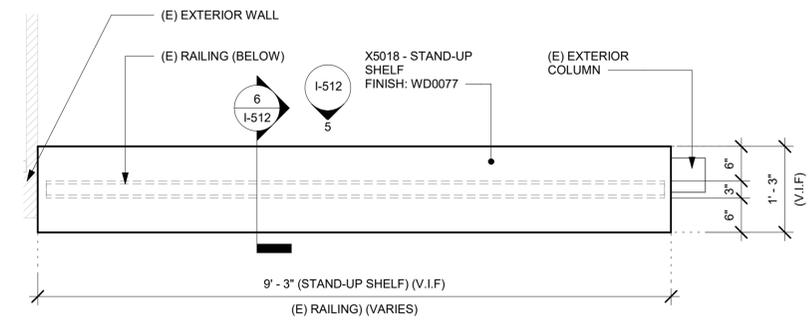

4 X5018 - STAND UP SHELF - PLAN  
Scale: 3/4" = 1'-0"

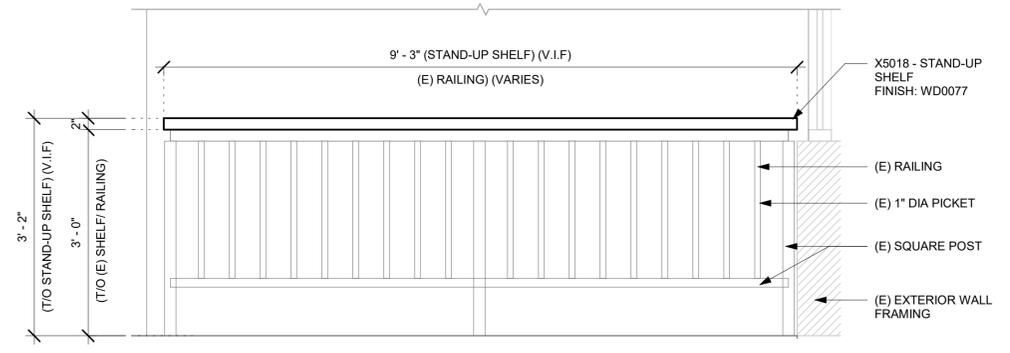

5 X5018 - STAND UP SHELF - ELEVATION  
Scale: 3/4" = 1'-0"

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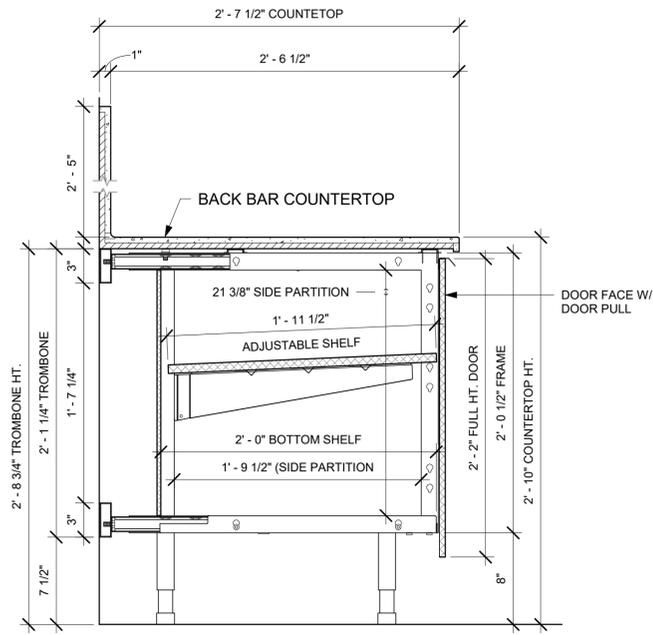
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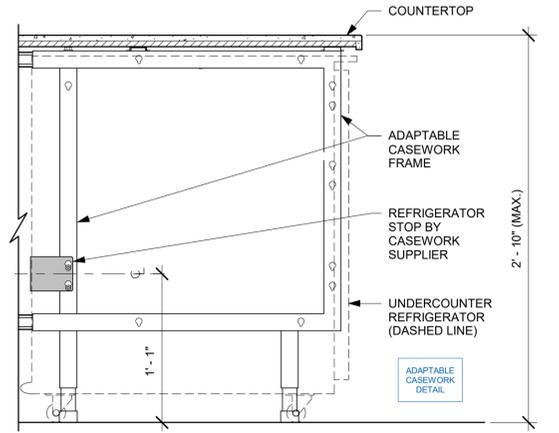
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**INTERIOR DETAILS**

SCALE: AS SHOWN


SHEET NUMBER:  
**I-513**




1 AC BACK BAR CABINET ASSEMBLY ON LEGS SECTION  
Scale: 1 1/2" = 1'-0"




2 AC UNDERCOUNTER REFRIGERATOR SECTION  
Scale: 1 1/2" = 1'-0"

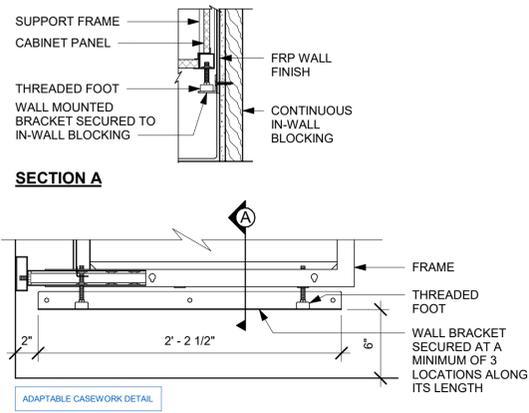


3 AC BACKLINE WALL BRACKET ASSEMBLY  
Scale: 1 1/2" = 1'-0"

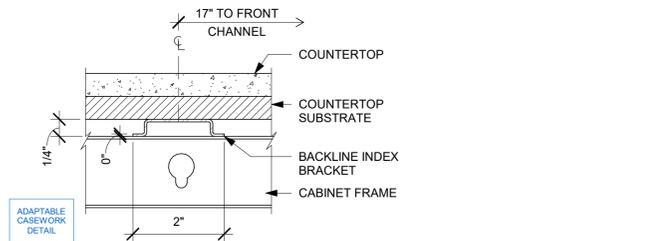

4 AC COUNTERTOP SUPPORT CHANNEL  
Scale: 6" = 1'-0"

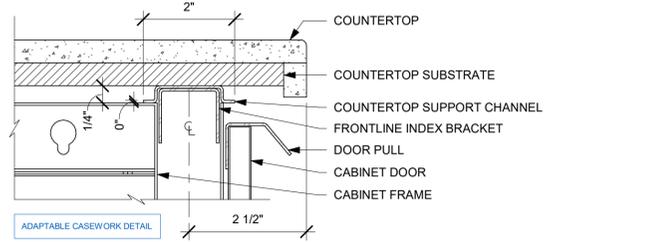

5 AC COUNTERTOP FRONT HAT SUPPORT CHANNEL  
Scale: 6" = 1'-0"

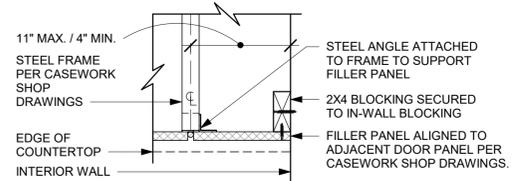

6 FILLER PANEL AT WALL  
Scale: 1 1/2" = 1'-0"

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DATA DEVICE SCHEDULE - "A"					
DESIGN ID	COUNT	DESCRIPTION	FURN. BY	INST. BY	COMMENTS
AUDIO VISUAL					
10005	1	MUSIC SYSTEM	SB	VD	
10012	1	DT COMMUNICATION SYSTEM	SB	VD	
10013	3	DT QUEUE CAMERA	SB	VD	
10015	3	SPEAKER RECESSED - WHITE	SB	GC	
10017	2	SPEAKER SURFACE MOUNTED	SB	GC	BLACK EXTERIOR
12336	1	DT TIMER SYSTEM	SB	VD	
19339	1	AMPLIFIER - 40W	SB	VD	
22549	3	SPEAKER GRILLE RECESSED - BLACK	SB	GC	
22725	1	DT DIGITAL PRODUCTION MONITOR	SB	VD	
22726	1	DT POS MONITOR ARM TRIPLE SURFACE MOUNTED	SB	VD	PART OF RETAIL IT EQUIPMENT PACKAGE
DATA					
10002	1	COMPUTER MANAGER WORKSTATION	SB	VD	
10007	1	PRINTER MANAGER WORKSTATION	SB	VD	
18744	1	EQUIPMENT RACK WITH LOCK - 24IN 610MM	SB	GC	
20294	4	IOT MODULE	SB	GC	
POINT OF SALE					
10008	1	POS - REGISTER WITH COMPACT CASH DRAWER	SB	VD	
10014	2	POS PRINTER	SB	VD	
10022	1	MONEY COUNTER	SB	VD	
10029	4	POS BANK	SB	GC	
10075	4	CUP LABELER	SB	VD	
14677	1	POS - DT TENDERING REGISTER	SB	VD	PART OF RETAIL IT EQUIPMENT PACKAGE
14678	1	POS - DT EXPEDITOR	SB	VD	PART OF RETAIL IT EQUIPMENT PACKAGE
SECURITY					
10025	1	SAFE RH - 20X18X28IN 510X455X660MM	SB	GC	
10028	1	SAFE BASE	SB	GC	

WALL BASE SCHEDULE - "B"					
DESIGN ID	LENGTH	DESCRIPTION	FURN. BY	INST. BY	COMMENTS
METAL BASE					
X9101	11' - 11"	METAL BASE - 6IN 150MM - BLACK - MT0028	GC	GC	PROVIDED BY CASEWORK VENDOR
TILE BASE					
19795	277' - 5 3/4"	POLYVINYL TILE BASE SHEET - ECO-GRIP - PEWTER - 6X96IN 150X2438MM	GC	GC	
X9102	27' - 6 1/2"	SCHLUTER BASE - DILEX - AHK ALUMINUM TRIM	GC	GC	SCHLUTER SYSTEM WILL REQUIRE USE OF 90 DEGREE CORNER PIECE TO ACCOMMODATE FOR RADIUS TRIM PROFILE.

DOOR SCHEDULE - "D"					
DESIGN ID	COUNT	DESCRIPTION	FURN. BY	INST. BY	COMMENTS
DOOR					
10190	1	DOOR - SINGLE FLUSH - 36IN - TYPE E	SB	GC	DOOR FINISH: WD0035 (STAIN TO MATCH); FRAME FINISH: SW6991-SG; LOCKNET; SEE HARDWARE SET #6; DOOR TYPE E
X2001	1	DOOR - STOREFRONT METAL FRAME SINGLE - TYPE B	EXIST	EXIST	DOOR; LOCKNET; DOOR FINISH: DID19458 DUSTED CRYSTAL; FRAME FINISH: BLACK ANODIZED ALUMINUM; SEE HARDWARE SET # 2
X2002	1	DOOR - SINGLE FLUSH - SERVICE DOOR - 42IN - TYPE F	EXIST	EXIST	DOOR FINISH: SW7033-ES; FRAME FINISH: SW7033-SG; LOCKNET; SEE HARDWARE SET #42; DOOR TYPE F;

FURNITURE SCHEDULE - "F"					
DESIGN ID	COUNT	DESCRIPTION	FURN. BY	INST. BY	COMMENTS
CHAIR					
21373	3	CHAIR - CAFE PEGGY UPHOLSTERED - WALNUT AND CARAMEL BROWN NATURAL WD0077 F0008	SB	GC	
21538	1	CHAIR - CAFE DAPHNE UPHOLSTERED - BLACK AND CARAMEL BROWN NATURAL WD0035 F0008	SB	GC	
TK0077	1	CHAIR - MANAGERS WORKSTATION	SB	GC	STEELCASE SERIES ONE ARMLESS
DESK					
TK0053	1	DESK - MANAGERS WORKSTATION SHELVES - 48IN 1220MM	SB	GC	
TK0076	1	DESK - MANAGERS WORKSTATION - 48X24X27IN 1220X610X685MM	SB	GC	
MIRROR					
10093	1	MIRROR - RESTROOM - 18X30IN 455X760MM	SB	GC	
TK0050	1	MIRROR - BOH - 16X51IN 405X1295MM	SB	GC	SEE DETAIL: 1/I-512
OTHER					
10756	1	COAT HOOK 1 PRONG SQUARE - 2IN 50MM - SST	SB	GC	
TK0051	1	COAT HOOK STRIP - 30IN 760MM	SB	GC	BLACK FINISH
STORAGE					
TK0078	1	FILE MOBILE PEDESTAL WITH CUSHION AND LOCK	SB	GC	
TK0079	1	MANAGERS DESK CART - 24X20IN 610X510MM	SB	GC	
TABLE					
21449	1	TABLE - BASE CAFE HEIGHT BOTTLE - FLAT BLACK MT0028	SB	GC	
21844	1	TABLE - TOP ROUND EDGE ROUND - 30IN 760MM - WALNUT WD0077	SB	GC	
TK0027	1	TABLE - OCCASIONAL SIDE COCO	SB	GC	CONTACT: TRADE@BLUDOT.COM
WINDOW TREATMENT					
22486	9	ROLLER SHADE - DARK BROWN - 5PC OPEN	SB	VD	LENGTH TO ALIGN WITH BOTTOM MULLION; LENGTH REQUIRED: (9) 3' - 1 1/4" LENGTH

CASEWORK SCHEDULE - "C"					
DESIGN ID	COUNT	DESCRIPTION	FURN. BY	INST. BY	COMMENTS
CABINET					
17580	2	CABINET - CBE TEA SHELF - 29IN 735MM - FLAT BLACK MT0028	SB	GC	PROVIDED BY CASEWORK VENDOR
19281	2	CABINET - ESPRESSO ICE BIN STAINLESS - 20IN 510MM	SB	GC	
21890	33	CABINET - SIDE PANEL	SB	GC	
21891	13	CABINET - BOTTOM SHELF - 15IN 380MM	SB	GC	
21892	8	CABINET - BACK PANEL - 15IN 380MM	SB	GC	
21893	8	CABINET - ADJUSTABLE SHELF - 15IN 380MM	SB	GC	
21894	12	CABINET - DOOR - 15IN 380MM	SB	GC	FINISH: CP0024
21895	6	CABINET - DOOR TRASH - 15IN 380MM	SB	GC	FINISH: CP0024
21896	1	CABINET - DRAWER - 15IN 380MM	SB	GC	FINISH: CP0024
21898	1	CABINET - BOTTOM SHELF - 18IN 455MM	SB	GC	
21901	1	CABINET - DOOR - 18IN 455MM	SB	GC	FINISH: CP0024
21902	6	CABINET - BOTTOM SHELF - 30IN 760MM	SB	GC	
21903	4	CABINET - BACK PANEL - 30IN 760MM	SB	GC	
21904	6	CABINET - ADJUSTABLE SHELF - 30IN 760MM	SB	GC	
21905	5	CABINET - DOOR - 30IN 760MM	SB	GC	FINISH: CP0024
21907	3	CABINET - END CAP BACKBAR	SB	GC	FINISH: CP0024
21908	4	CABINET - FILLER PANEL - VARIABLE LENGTH	SB	GC	FINISH: CP0024; LENGTH REQUIRED: (1) 0' - 3 1/4" (1) 0' - 2" (1) 0' - 3"
21909	1	CABINET - DT POS UPPER CUBBY - 32IN 815MM	SB	GC	FINISH: PL0019
21910	1	CABINET - FRENCH CLEAT - VARIABLE LENGTH	SB	GC	OVERALL LENGTH REQUIRED: 2' - 6 1/2"
21912	1	CABINET - BACK PANEL FOR POS - 30IN 760MM	SB	GC	
21913	3	CABINET - EQUIPMENT MOUNTING PANEL	SB	GC	
22632	1	CABINET - CBE DRY INCLUSION SHELF - 44IN 1120MM - FLAT BLACK MT0028	SB	GC	PROVIDED BY CASEWORK VENDOR
22749	1	CABINET - ESPRESSO PUMP MOUNT PANEL	SB	GC	
22980	2	CABINET - ADJUSTABLE SHELF - 21IN 535MM	SB	GC	
22981	1	CABINET - BACK PANEL FOR POS - 21IN 535MM	SB	GC	
22982	1	CABINET - BOTTOM SHELF - 21IN 535MM	SB	GC	
X5006	2	CUSTOM CABINET - BACKBAR - 37.5IN 950MM	SB	GC	FINISH: PL0019; SEE DETAIL: 5/I-508; PROVIDED BY CASEWORK VENDOR
X5013	1	CUSTOM CABINET - BACKBAR COUNTER SUPPORT PANEL - 3IN 75MM	SB	GC	FINISH: PL0019; SEE DETAIL: 3/I-508; SIMILAR TO DW #17573; CUSTOM DUE TO DEPTH; PROVIDED BY CASEWORK VENDOR
COUNTERTOP					
21919	5	COUNTERTOP - FILLER BACKBAR - VARIABLE LENGTH	SB	GC	FINISH: CP0030; LENGTH REQUIRED: (2) 0' - 2 3/4" (2) 0' - 2 1/4" (1) 0' - 1 1/2"
21925	3	COUNTERTOP - BACKBAR - 15IN 380MM	SB	GC	FINISH: CP0030
21927	2	COUNTERTOP - BACKBAR - 30IN 760MM	SB	GC	FINISH: CP0030
21928	3	COUNTERTOP - END CAP BACKBAR	SB	GC	FINISH: CP0030
22331	1	COUNTERTOP - BREW - RF - 105IN 2665MM	SB	GC	FINISH: CP0030
22356	1	COUNTERTOP - ESPRESSO BACKBAR - RF - 141IN 3580MM	SB	GC	FINISH: CP0030
22362	1	COUNTERTOP - DT POS - LF - 76IN 1930MM	SB	GC	FINISH: CP0030
22386	1	COUNTERTOP - WARMING WITH RACK - LF - 125IN 3175MM	SB	GC	FINISH: CP0030
22395	1	COUNTERTOP - HAND SINK LOW SPLASH - 15IN 380MM	SB	GC	
22635	1	COUNTERTOP - CBE - LF - 152IN 3860MM	SB	GC	FINISH: CP0030
X5001	1	CUSTOM COUNTERTOP - ESPRESSO BACKBAR - LF - 47.75IN 1215MM	SB	GC	FINISH: CP0030; SEE DETAIL: 1/I-508; PROVIDED BY CASEWORK VENDOR
X5002	1	CUSTOM COUNTERTOP - ADD PARTNER - 81.5IN 2070MM	SB	GC	FINISH: CP0030; SEE DETAIL: 2/I-508; PROVIDED BY CASEWORK VENDOR
X5003	10	CUSTOM COUNTERTOP - 2FT BACKSPLASH - VARIABLE LENGTH	SB	GC	FINISH: CP0030; SEE DETAIL: 9/I-507; PROVIDED BY CASEWORK VENDOR LENGTH REQUIRED: (1) 14" - 0 1/8" (1) 4" - 1" (1) 0' - 0 3/4" (1) 1' - 10 1/4" (1) 2' - 7 1/2" (1) 0' - 6 3/4" (1) 3' - 4 1/4" (1) 13' - 0" (1) 17' - 2 3/4" (1) 15' - 8"
X5004	3	CUSTOM COUNTERTOP - 2FT 5IN BACKSPLASH - VARIABLE LENGTH	SB	GC	FINISH: CP0030; PROVIDED BY CASEWORK VENDOR LENGTH REQUIRED: (2) 2' - 6 1/2" (1) 6' - 9 1/2"
X5005	1	CUSTOM COUNTERTOP - DT AREA BACKBAR - 79.5IN 2020MM	SB	GC	FINISH: CP0030; SEE DETAIL: 3/I-508; PROVIDED BY CASEWORK VENDOR
X5010	1	CUSTOM COUNTERTOP - 2FT BACKSPLASH - VARIABLE LENGTH	SB	GC	FINISH: CP0030; PROVIDED BY CASEWORK VENDOR LENGTH REQUIRED: (1) 1' - 3"
X5011	3	CUSTOM COUNTERTOP - 2FT BACKSPLASH - VARIABLE LENGTH	SB	GC	FINISH: CP0056; SEE DETAIL: 5/I-511; PROVIDED BY CASEWORK VENDOR LENGTH REQUIRED: (1) 0' - 10" (1) 0' - 11" (1) 10' - 4"
X5015	1	CUSTOM COUNTERTOP - DT POS - RF - 45IN 1145MM	SB	GC	FINISH: CP0030; SEE DETAIL: 4/I-508; PROVIDED BY CASEWORK VENDOR
DIEWALL					
21885	15	DIEWALL - FRAMING - VARIABLE LENGTH	SB	GC	
21888	46	DIEWALL - SUPPORT LEG	SB	GC	
OTHER					
10829	11	CORNER GUARD - .75IN 19MM	SB	GC	LOCATED @ BOH SST
11155	2	ESPRESSO MACHINE PUMP MOUNT - 10X10IN 255X255MM	SB	GC	
21914	8	FRIDGE STOP BRACKET SET	SB	GC	
X5007	2	CUSTOM WOOD SHELVES	SB	GC	FINISH: WD0077; SEE DETAIL: 1/I-509; PROVIDED BY CW VENDOR
X5008	1	CUSTOM DT SILL TOP	SB	GC	FINISH: CP0030; SEE DETAIL: 7/I-509; PROVIDED BY CASEWORK VENDOR
X5009	1	CUSTOM PICK UP WINDOW SILL TOP	SB	GC	FINISH: CP0030; SEE DETAIL: 4/I-509; PROVIDED BY CASEWORK VENDOR
X5012	1	CUSTOM PICK UP WINDOW SILL TOP	SB	GC	FINISH: CP0056; SEE DETAIL: 5/I-511; PROVIDED BY CASEWORK VENDOR
X5016	1	CUSTOM METAL FLAT BAR AT PARTNER'S AREA	SB	GC	FINISH: PAINTED TO MATCH SW7031-ES; SEE DETAIL: 6/A-502; PROVIDED BY CASEWORK VENDOR
X5017	1	CUSTOM METAL FLAT BAR AT WORKROOM	SB	GC	FINISH TO MATCH SW7031-ES; SEE DETAIL: 7/A-502; PROVIDED BY CASEWORK VENDOR
X5018	1	CUSTOM STAND-UP SHELF	SB	GC	FINISH: WD0077; SEE DETAIL: 4/I-512

SPECIALTY EQUIPMENT SCHEDULE - "E"					
DESIGN ID	COUNT	DESCRIPTION	FURN. BY	INST. BY	COMMENTS
COOLING					
10267	6	FRIDGE UNDERCOUNTER 1 DOOR - 27IN 685MM	SB	GC	
11083	2	FRIDGE REACH IN 2 DOOR - 51X35IN 1295X890MM	SB	GC	
12618	2	FRIDGE UNDERCOUNTER 1 DOOR WITH SHELF - 27IN 685MM	SB	GC	
13882	2	FREEZER REACH IN 2 DOOR - 54IN 1370MM	SB	GC	
20011	1	FRIDGE NITRO 2 TAP JT NITCOM RH	SB	GC	KIT INCLUDES UNDERCOUNTER FRIDGE, FONT, TRAY, AND TUBING
EQUIPMENT					
10312	3	BREWER SOFT HEAT WARMING STAND SINGLE	SB	GC	
10746	1	BREWER DUAL SOFT HEAT	SB	GC	
10808	1	GRINDER DITTING KR1203	SB	GC	
10856	5	BREWER SERVER SOFT HEAT	SB	GC	
10907	1	DISHWASHER LEGS AND SKIRT	SB	GC	
12508	2	BLENDER QUIET MODEL ON COUNTER	SB	GC	
15186	1	DISHWASHER LXER ADVANSYS	SB	GC	
19742	2	ESPRESSO MACHINE MASTRENA II	SB	GC	
20032	2	OVEN EIKON E2S - BLACK	SB	GC	
21679	1	NITROGEN GENERATOR ELEMENT COMPACT	SB	GC	
TK0052	1	OVEN SAMSUNG MICROWAVE MS14K6000AS - STAINLESS STEEL	SB	GC	
ICE					
10527	2	ICE - BIN DROP IN 45LB 20KG	SB	GC	
18029	1	ICE - BIN B110	SB	GC	BPF-1 ADAPTER KIT (011076103) REQUIRED WHEN PAIRING WITH 30" (760MM) ICE MACHINES
18846	1	ICE - MACHINE CIM1446HR SERIES REMOTE COOLED	SB	GC	
19278	2	ICE - BIN DROP IN 45LB 20KG HORIZONTAL	SB	GC	
OTHER					
10091	1	CUP DISPENSER TALL HOT VERTICAL	SB	GC	
10099	1	RESTROOM TOILET PAPER HOLDER	SB	GC	
10172	1	RESTROOM SEAT COVER DISPENSER	SB	GC	
10179	1	HAND DRYER SURFACE MOUNTED	SB	GC	
10396	1	CUP DISPENSER SHORT HOT VERTICAL	SB	GC	
10501	1	FIRE EXTINGUISHER	GC	GC	SPEC: MANUFACTURER: PRODUCT PRO 460; PART #21005785; MULTIPURPOSE DRY-CHEMICAL TYPE UL RATED A-A-60-B-C, 10LB; METAL STRAP BRACKET PART # 366242
10769	1	RESTROOM GRAB BAR VERTICAL - 18IN 455MM	SB	GC	
10791	2	CUP DISPENSER GRANDE VENTI COLD VERTICAL	SB	GC	
10855	2	CUP DISPENSER GRANDE VENTI HOT VERTICAL	SB	GC	
10858	1	CUP DISPENSER TALL COLD VERTICAL	SB	GC	
10859	1	RESTROOM GRAB BAR - 48IN 1220MM	SB	GC	
10862	1	RESTROOM GRAB BAR - 36IN 915MM	SB	GC	
10947	2	SOAP DISPENSER WALL MOUNTED	SB	GC	
10977	1	PAPER TOWEL DISPENSER FULL SIZE	SB	GC	
10992	1	PAPER TOWEL DISPENSER HALF SIZE - TRANSLUCENT GRAY	SB	GC	
11115	1	SOAP DISPENSER SINK MOUNTED	SB	GC	
13330	1	MOBILE CUP DISPENSER CADDY	SB	GC	
13584	1	CUP DISPENSER TRENTA COLD VERTICAL	SB	GC	
20403	6	KEG - 3GAL	SB	GC	
21988	1	HAND DRYER BACK PANEL	SB	GC	
22627	1	NITRO 2 TAP HANDLE WITH BADGE AND MOUNT KIT	SB	GC	JOE TAP, FOR USE AT BACKBAR NITRO FONT
STORAGE					
10222	2	WIRE SHELF GRID AT SINK	SB	GC	
10416	9	WORKROOM SHELVING - 36IN 915MM	SB	GC	
10462	9	WORKROOM SHELVING POSTS	SB	GC	
10698	1	MOP RACK WITH 3 HOLDERS	SB	GC	
10838	1	ROLLING WIRE CART FOR 3 COMP SINK	SB	GC	
13834	1	BASE - 24X18IN 610X455MM	SB	GC	
17264	1	ROLLING PASTRY TRAY THAW RACK - 20X26IN 510X660MM	SB	GC	
21934	1	PASTRY TRAY RACK UNDERCOUNTER - 30IN 760MM	SB	GC	
22212	1	WORKROOM SHELVING CART KIT	SB	GC	
TK0048	2				

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GRAPHICS AND ARTWORK SCHEDULE - "G"						
DESIGN ID	COUNT	DESCRIPTION	FURN. BY	INST. BY	COMMENTS	
GRAPHIC - FILM						
19458	18	INTERIOR WINDOW FILM FASARA - DUSTED CRYSTAL	SB	GC	SIZE REQUIRED: (V.I.F.): (8) 3' - 1 1/4" W X 8' - 10" H (9) 3' - 1 1/4" W X 2' - 8" H (1) 2' - 4 3/4" W X 5' - 9 1/2" H	
GRAPHICS - ARTWORK						
X1001	1	SBXART_22711 - WRAPPED CANVAS IN FLOAT FRAME; ART SIZE: 35" W X 35" H; REVEAL: 25" - PRINT TO EDGES - PRINT EDGES BLACK - OVERALL SIZE: 36" W X 36" H - CANVAS 1; FRAME: 3A - FRAME 623674 EBONIZED WALNUT	SB	GC	SEE ELEVATION: 1/1-203	
X1002	1	SBXART_22679 - WRAPPED CANVAS IN FLOAT FRAME; ART SIZE: 35" W X 35" H; REVEAL: 25" - PRINT TO EDGES - PRINT EDGES BLACK - OVERALL SIZE: 36" W X 36" H - CANVAS 1; FRAME: 3A - FRAME 623674 EBONIZED WALNUT	SB	GC	SEE ELEVATION: 1/1-203	
X1003	1	SBXART_16969 - FRAMED AND MATTED; ART SIZE: 12" W X 12" H; MAT BORDER 3IN; OVERALL SIZE: 19 1/2" W X 19 1/2" H; PAPER 1 - MAT 1 - FRAME 1A (EBONIZED WALNUT)	SB	GC	SEE ELEVATION: 6/1-202	
X1004	1	SBXART_22483 - FRAMED AND MATTED; ART SIZE: 12" W X 12" H; MAT BORDER 3IN; OVERALL SIZE: 19 1/2" W X 19 1/2" H; PAPER 1 - MAT 1 - FRAME 1A (EBONIZED WALNUT)	SB	GC	SEE ELEVATION: 6/1-202	
GRAPHICS - OTHER						
11135	1	RESTROOM SIGN UNISEX ACCESSIBLE	SB	GC		

LIGHTING FIXTURE SCHEDULE - "L"						
DESIGN ID	COUNT	DESCRIPTION	FURN. BY	INST. BY	BULB	COMMENTS
EXIT						
19044	3	LED EXIT SIGN WITH EMERGENCY LIGHT - WHITE AND RED	SB	GC	INTEGRATED LED	
19047	1	LED EXIT SIGN WITH EMERGENCY LIGHT - BLACK AND GREEN	SB	GC	INTEGRATED LED	
19056	1	LED EMERGENCY LIGHT DOUBLE - WHITE	SB	GC	INTEGRATED LED	
PENDANT						
21422	1	PENDANT - REJUVENATION ABIGAIL SOFT CONE - UNGLAZED TOAST	SB	GC	6 W LED, AS PACKAGED	
RECESSED CAN						
X7001	17	CAN - CUSTOM RECESSED - BLACK - 1155LM FLOOD WITH DIMMER	SB	GC	INTEGRATED LED	
SCONCE						
20748	1	SCONCE - KUJCO PLUTO TRIPLE - CHROME	SB	GC	INTEGRATED LED	
TRACK						
12948	4	TRACK - WITH CONNECTORS - 16FT 488CM - BLACK - 1 CIRCUIT	SB	GC		ALL BAR / CAFE TRACK LIGHTING TO BE RUN THROUGH 1A / 2A CURRENT LIMITING DEVICE #RCLF12BL-TCL2BL; SEE ELECTRICAL DRAWINGS FOR ADDITIONAL INFORMATION
15058	2	TRACK - WITH CONNECTORS - 6FT 183CM - BLACK - 1 CIRCUIT	SB	GC		ALL BAR / CAFE TRACK LIGHTING TO BE RUN THROUGH 1A / 2A CURRENT LIMITING DEVICE #RCLF12BL-TCL2BL; SEE ELECTRICAL DRAWINGS FOR ADDITIONAL INFORMATION
21779	22	TRACK - LED FIXTURE WITH SNOOT - 3IN 75MM - BLACK - 1100LM FLOOD	SB	GC	INTEGRATED LED	
TROFFER						
21783	7	TROFFER - LED RECESSED - 24X48IN 600X1200MM - WHITE - 4300LM	SB	GC	INTEGRATED LED	

MECHANICAL EQUIPMENT SCHEDULE - "M"						
DESIGN ID	COUNT	DESCRIPTION	FURN. BY	INST. BY	COMMENTS	
OTHER						
17797	1	ENERGY MANAGEMENT SYSTEM - HVAC ONLY	SB	GC		

PAINT SCHEDULE						
COLOR CODE	DESCRIPTION	LRV	FURN. BY	INST. BY	COMMENTS	
SW6991-SG	SW - BLACK MAGIC - SEMIGLOSS	6	GC	GC	USE PRIMER CP-1	
SW7031-ES	SW - MEGA GREIGE - EGGSHELL	37	GC	GC	USE PRIMER CP-1	
SW7033-ES	SW - BRAINSTORM BRONZE - EGGSHELL	15	GC	GC	USE PRIMER CP-1	
SW7033-SG	SW - BRAINSTORM BRONZE - SEMIGLOSS	15	GC	GC	USE PRIMER CP-1	
SW7631-ES	SW - CITY LOFT - EGGSHELL	70	GC	GC	USE PRIMER CP-1	

WALL TREATMENT (AREA) SCHEDULE - "Q"						
DESIGN ID	AREA	DESCRIPTION	FURN. BY	INST. BY	COMMENTS	
PLASTIC						
11469	1649 SF	FRP - WHITE	GC	GC		
TILE						
20227	241 SF	TILE - 1 COCCI - CEMENTO - 6X24IN 150X600MM	SB	GC	GROUT: MAPEI - 47 CHARCOAL, OR EQUAL	
X9202	480 SF	TILE - GEO - BEIGE - MATTE - 3X10IN 75X255MM	SB	GC	GROUT MAPEI 106 WALNUT-3/16"; VD: FIVE STAR CERAMICS GROUP; CONTACT INFO: CHRISM@FIVESCG.COM	
WALLCOVERING						
17854	113 SF	VINYL WALL COVERING - TADAO - STARBUCKS WG11184374	SB	GC		

WALL TREATMENT (LENGTH) SCHEDULE - "R"						
DESIGN ID	LENGTH	DESCRIPTION	FURN. BY	INST. BY	COMMENTS	
TRIM						
X9201	56' - 9 1/2"	QUADEC SCHLUTER JOLLY TRIM; 6MM FINISH: CREAM	GC	GC	LOCATION: BACKBAR TILE CORNER; SEE DETAIL: 889I-502; GC TO VERIFY LENGTHS	

PLUMBING FIXTURE SCHEDULE - "P"						
DESIGN ID	COUNT	DESCRIPTION	FURN. BY	INST. BY	COMMENTS	
DRAIN						
10294	7	DRAIN - FLOOR SINK SQUARE - 12IN 305MM	SB	GC		
10594	1	DRAIN - FLOOR SINK SQUARE - 5IN 125MM	GC	GC	ZURN ZN415B	
10726	7	DRAIN - GRATE HALF SQUARE - 12IN 305MM	SB	GC		
EQUIPMENT						
X8019	1	HOT WATER RECIRCULATION PUMP	SB	GC	BELL & GOSSETT MODEL NBF-36 PUMP WITH BELL & GOSSETT AQS-3/4 AQUASTAT, AND BELL & GOSSETT TC-1 AUTOMATIC TIMER	
FAUCET						
10152	2	FAUCET - DOUBLE LABORATORY WITH BENT RISER SPOUT	SB	GC		
10153	4	FAUCET - WATER TOWER - 12IN 305MM	SB	GC		
10215	2	FAUCET - DOUBLE LABORATORY WITH SWING SPOUT	SB	GC		
10447	1	FAUCET - PRE RINSE SPRAYER WALL MOUNTED	SB	GC		
10597	1	FAUCET - SINGLE HANDLE	SB	GC		
10804	1	FAUCET - PRE RINSE SWING SPOUT	SB	GC		
10874	1	FAUCET - INSTAHOT SYSTEM SINGLE LEVER	SB	GC		
10922	1	FAUCET - MOP SINK WALL MOUNTED	SB	GC		
10943	1	FAUCET - SINGLE LABORATORY WITH SWING SPOUT	SB	GC		
11003	2	FAUCET - METERED	SB	GC		
13588	1	FAUCET - HAND SINK WALL MOUNTED	SB	GC		
21352	1	FAUCET - RESTROOM WITH MOTION SENSOR	SB	GC		
22642	2	FAUCET - INSTANTHOT SYSTEM 2 BUTTON WITH BOILER AND BRACKET	SB	GC	KIT INCLUDES FONT, UNDERCOUNTER BOILER AND BOILER BRACKET FOR SIDE PANEL MOUNTING. BRACKET CAN BE FLOOR MOUNTED USING SET OF (4) STAINLESS STEEL LEGS, ORDERED SEPARATELY THROUGH VENDOR.	
FILTER						
12501	1	FILTER - RO SYSTEM 600GPD	SB	VD		
12507	1	FILTER - RO SYSTEM STORAGE TANK RO40	SB	VD		
12896	1	FILTER - BRINE TANK	SB	VD		
12899	2	FILTER - POLY GLASS VESSEL	SB	VD		
13076	1	FILTER - PREFILTRATION SYSTEM	SB	VD		
13082	1	FILTER - WATER SOFTENER TWIN	SB	VD		
OTHER						
22224	1	WATER HEATER TANK ELECTRIC - 13.5W	SB	GC	13.5KW 208/3 BRADFORD WHITE E32-50S-3 30GAL ELECTRIC	
SINK						
10116	1	SINK - RESTROOM WALL MOUNTED	SB	GC		
10549	2	SINK - RINSE DROP IN SST - 12X20IN 305X510MM	SB	GC		
10995	1	SINK - MOP - 24X24IN 610X610MM	SB	GC		
13700	1	SINK - 3 COMP WORK SST - 105IN 2665MM	SB	GC		
14688	1	SINK - HAND WITH SIDE SPLASH WALL MOUNTED SST	SB	GC		
18743	1	SINK - WATER FILLING STATION - 36X24IN 915X610MM	SB	GC		
22630	1	SINK - RINSE DROP IN - 27X26IN 685X670MM	SB	GC		
22768	2	SINK - COUNTERTOP RINSER WITH WATER TOWER - 26X9IN 660X235MM	SB	GC		
TOILET						
11871	1	TOILET - WITH TANK SINGLE FLUSH	GC	GC	WC TO BE PURCHASED THROUGH FERGUSON; NA.PROJECTS@FERGUSON.COM	

SIGNAGE SCHEDULE - "S"						
DESIGN ID	COUNT	DESCRIPTION	FURN. BY	INST. BY	COMMENTS	
SIGNAGE - DISK						
13182	1	SIGN - DISK SF ILLUMINATED FLUSH MOUNTED EVOLVED - 71IN 1805MM	SB	VD		
SIGNAGE - DRIVE THRU						
14091	1	SIGN - DT DIRECTIONAL EXIT SIGN ILLUMINATED ARROW SERIES - 46IN 1170MM	SB	VD	SEE DETAIL: 5 & 7/APX-104	
14099	2	SIGN - DRIVE THRU ILLUMINATED ARROW SERIES FLUSH MOUNTED - RH - 48IN 1220MM	SB	VD		
14104	1	SIGN - DT DIRECTIONAL ILLUMINATED ARROW SERIES WITH LOGO - 46IN 1170MM	SB	VD	SEE DETAIL: 4 & 7/APX-104	
22544	1	SIGN - DT CLEARANCE BAR SQUARE FRAME FREESTANDING - BLACK AND DARK GREEN	SB	VD	SEE DETAIL: 2 & 3/APX-104	
SIGNAGE - OTHER						
21297	2	SIGN - 5 MINUTE PARKING	SB	VD	POST, IF REQUIRED, PROVIDED BY OTHERS	
X0001	1	MONUMENT SIGN	SB	VD		
X0002	1	PICK UP SIGNAGE - EXTERIOR	SB	VD	SEE DETAIL: 1/1-510	
SIGNAGE - WORDMARK						
18497	2	SIGN - WORDMARK STARBUCKS FLUSH MOUNTED - 18IN 455MM	SB	VD	WHITE LETTERS	

FLOOR TREATMENT SCHEDULE - "T"						
DESIGN ID	AREA	DESCRIPTION	FURN. BY	INST. BY	COMMENTS	
TILE						
19795	1117 SF	POLYVINYL FLOOR SHEET - ECO-GRIP - PEWTER - 60X96IN 1524X2438MM	GC	GC		
20228	59 SF	TILE - 1 COCCI - CEMENTO - 24X24IN 600X600MM	SB	GC	GROUT: MAPEI - 47 CHARCOAL, OR EQUAL	

CEILING TREATMENT SCHEDULE - "U"						
DESIGN ID	AREA	DESCRIPTION	FURN. BY	INST. BY	COMMENTS	
OTHER						
19734	833 SF	ACT - ULTIMA - 2X2FT 61X61CM	GC	GC	FACTORY FINISHED SW7031 MEGA GREIGE; FOR ORDERING CONTACT DEB PICKENS AT DPLPICKENS@ARMSTRONGCEILINGS.COM, PH: 480-695-9053	

STOREFRONT SCHEDULE - "W"						
DESIGN ID	COUNT	DESCRIPTION	FURN. BY	INST. BY	COMMENTS	
WINDOW						
10118	2	WINDOW - DT HURRICANE RATED - 48X44IN 1205X1105MM - ALUMINUM	EXIST	EXIST	LL TO SPECIFY IMPACT GLASS OR NON-IMPACT GLASS AS REQUIRED. CONTACT DAN RADEK AT dan@ready-access.com 1-800-621-5045	

### RESPONSIBILITY LEGEND

FURN. BY	INST. BY
SB - FURNISHED BY STARBUCKS	GC - INSTALLED BY GENERAL CONTRACTOR
GC - FURNISHED BY GENERAL CONTRACTOR	SB - INSTALLED BY STARBUCKS
VD - FURNISHED BY VENDOR	VD - INSTALLED BY VENDOR

**NOTE:** ALL RESPONSIBILITIES TO BE CONFIRMED WITH STARBUCKS CONSTRUCTION MANAGER PRIOR TO ORDERING / CONSTRUCTION.

**REVIEWED FOR CODE COMPLIANCE**  
 Wayne Thorne - PX3005 11-09-23  
 A PERMIT ISSUED SHALL BE CONSTRUED TO BE A LICENSE TO PROCEED WITH THE WORK AND NOT AS AN AUTHORITY TO VIOLATE, CANCEL, ALTER OR SET ASIDE ANY OF THE PROVISIONS OF THE TECHNICAL CODES, NOR SHALL ISSUANCE OF A PERMIT PREVENT THE BUILDING OFFICIAL FROM THEREAFTER REQUIRING A CORRECTION OF ERRORS IN PLANS, CONSTRUCTION OR VIOLATIONS OF THIS CODE.



SITE COPY BC23-000692

SITE SCHEDULE - "Y"						
DESIGN ID	COUNT	DESCRIPTION	FURN. BY	INST. BY	COMMENTS	
EXTERIOR MENU						
13605	4	MENU BOARD - WALK UP - 28X21IN 710X535MM	SB	VD		
18984	4	MENU BOARD - UNIVERSAL WALL MOUNT BRACKET	SB	GC		
22540	1	MENU BOARD - DT 5 PANEL SQUARE FRAME FREESTANDING - 95X62IN 2415X1575MM - BLACK	SB	VD	SEE DETAIL: 1/APX-103	
22542	1	MENU BOARD - DT PRE MENU SQUARE FRAME FREESTANDING - 29X61IN 735X1550MM - BLACK	SB	VD	SEE DETAIL: 3/APX-103	
22546	1	MENU BOARD - DT DIGITAL ORDER SCREEN WITH POST - BLACK	SB	VD	SEE DETAIL: 1/APX-103.2	
OTHER						
10042	2	BIKE RACK HOOP	EXIST	EXIST	SEE DETAIL: 10 & 11/APX-104	
10163	1	DT WINDOW SHELF - 56IN OBSIDIAN PAPERSTONE	EXIST	EXIST	SEE DETAIL: 4/APX-103.1	
14095	1	DT WAYFINDING GRAPHIC EXIT ARROW - WHITE	EXIST	EXIST	SEE DETAIL: 9/APX-104	
14101	1	DT WAYFINDING GRAPHIC ENTRY ARROW - GREEN	EXIST	EXIST	SEE DETAIL: 8/APX-104	
14323	2	DT WAYFINDING GRAPHIC DIRECTIONAL DOUBLE ARROW - GREEN	EXIST	EXIST	REFERENCE PAINT P936 FOR SPECIFICATIONS; SEE DETAIL: 6/APX-104	
14324	2	DT WAYFINDING GRAPHIC DIRECTIONAL DOUBLE ARROW - WHITE	EXIST	EXIST	REFERENCE PAINT P935 FOR SPECIFICATIONS; SEE DETAIL: 6/APX-104	
22543	1	DT ORDER POINT CANOPY SQUARE FRAME - BLACK	SB	VD	SEE DETAIL: 2/APX-103.2	
X4001	4	CIRCULAR BOLLARD - 6" DIA	EXIST	EXIST	SEE DETAIL: 1/APX-104	
X4002	1	PATIO RAILING	EXIST	EXIST	SEE DETAIL: 4/APX-105	
X4003	1	LOUVERS AT STOREFRONT - LINEAR SUNSHADES #543 MEDIUM BRONZE	SB	VD	SEE DETAIL: 1/1-511; VD: SUN CONTROL SOLUTIONS; WWW.C-SGROUP.COM	
X4004	2	LOUVERS AT STOREFRONT - LINEAR SUNSHADES #543 MEDIUM BRONZE	SB	VD	SEE DETAIL: 1/1-511; VD: SUN CONTROL SOLUTIONS; WWW.C-SGROUP.COM	

FOR CONSTRUCTION



**STARBUCKS**  
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STARBUCKS TEMPLATE VERSION: I2021-09-13

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PROJECT NAME:  
**US 17-92 & LAKE MARY BLVD**  
 PROJECT ADDRESS:  
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 SANFORD, FL 32773**

STORE #: 81065  
 PROJECT #: 98504-001  
 ISSUE DATE: 08-03-2023  
 DESIGNER: PAULINA LOPEZ  
 PRODUCTION DESIGNER: ANDY MCLLOUD  
 CHECKED BY: DONALD RETHMAN

Revision Schedule			
Rev	Date	By	Description

SHEET TITLE:  
**SCHEDULES**

SCALE: NO SCALE

SHEET NUMBER:  
**I-602**